
ROCKDALE COUNTY FIRE TRAINING CAMPUS

3111 SW HIGHWAY 212 CONYERS, GEORGIA 30012

PREPARED FOR:

ROCKDALE COUNTY GOVERNMENT 958 MILSTEAD AVE NE, CONYERS, GA 30012

208 Pirkle Ferry Road, Suite C Cumming, GA 30040

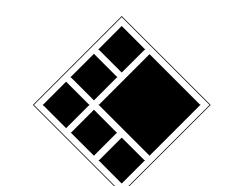

BREEDLOVE LAND PLANNING Landscape Architects ◆ Civil Engineers 15 Simpson Street, NW, Atlanta, GA 30308 P: 770-483-1173 ◆ www.landplanning.net

BLP PROJ. NO. 22158



~

PRINT RECORD No. DATE **DESCRIPTION** 1 07/31/2023 LDP SUBMITTAL 09/07/2023 LDP RESUBMITTAL LDP RESUBMITTAL 3 | 10/12/2023 4 01/16/2024 LDP RESUBMITTAL

ROCKDALE COUN COMMISSIONERS

Drawn By Checked By


Job No. 05/05/2023


Sheet Title


COVER SHEET

Sheet No.

PROJECT INFORMATION

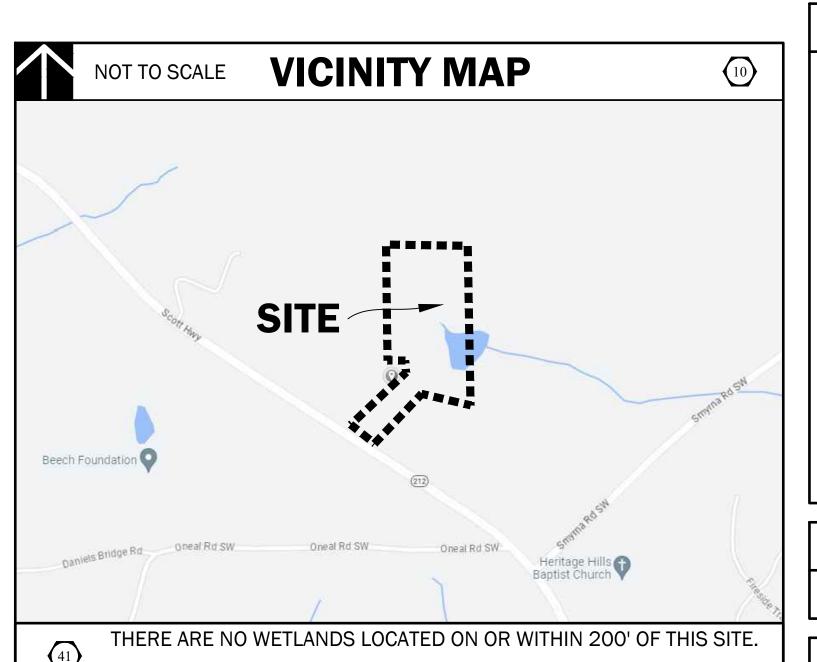

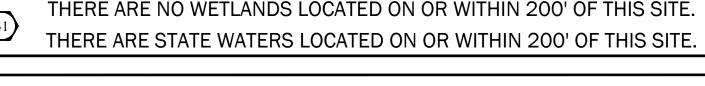

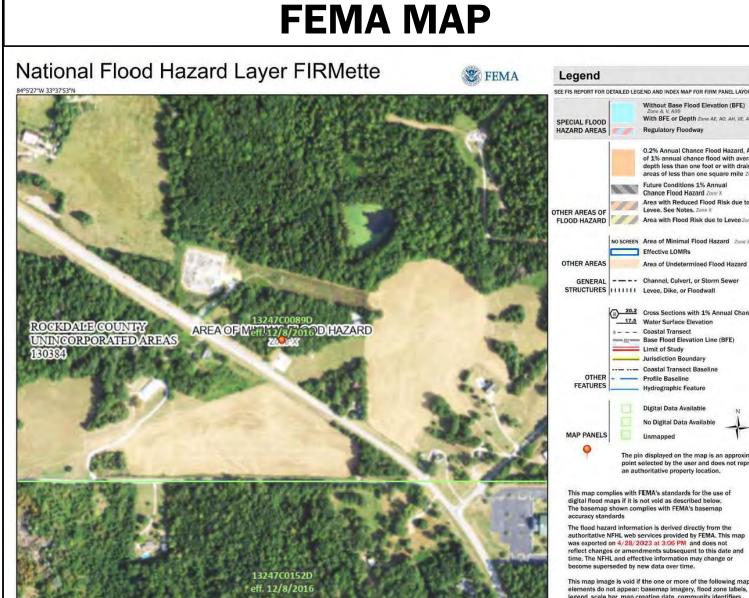

PROJECT CONTACTS NAME: ROCKDALE COUNTY BOARD OF COMMISIONERS ADDRESS: 958 MILSTEAD AVENUE SE CITY, ST, ZIP: CONYERS, GA 30012 CONTACT: ANDREW HAMMER PHONE: 678-387-7081 EMAIL: ANDREWHAMMER®ROCKDALECOUNTYGAGOV NAME: JERICHO DESIGN GROUP ADDRESS: 208 PIRKLE FERRY ROAD, SUITE C CITY, ST, ZIP: CUMMING, GA 30040 CONTACT: DOUG SHAW PHONE: 470-529-1043 EMAIL: DSHAW@JERICHO-DESIGN.COM NAME: BREEDLOVE LAND PLANNING, INC. ADDRESS: 15 SIMPSON STREET NW CITY, ST, ZIP: ATLANTA, GA, 30308 CONTACT: MATT TANNER, PE PHONE: 770-483-1173 EMAIL: MTANNER@LANDPLANNING.NET NAME: ROCHESTER AND ASSOCIATES, LLC ADDRESS: 425 OAK STREET NW CITY/STATE/ZIP: GAINESVILLE, GA 30501 CONTACT: AJ ALLISON EMAIL: AJALLISION@ROCHESTER-ASSOC.COM

ROCKDALE COUNTY NOTES ANY ROCKDALE COUNTY INFRASTRUCTURE OR PROPERTY DAMAGED DURING, OR AS A RESULT OF, CONSTRUCTION OF THIS PROJECT WILL BE REPAIRED OR REPLACED

ROCKDALE COUNTY NOTES

TO THE SATISFACTION OF ROCKDALE COUNTY

With BFE or Depth Zone AE, AO, AH, VE. AR

depth less than one foot or with drain areas of less than one square mile Zor

Area with Reduced Flood Risk due to Levee. See Notes, Zane X

Regulatory Floodway

_____17.5 Water Surface Elevation

Jurisdiction Boundary

No Digital Data Available

point selected by the user and does not repre

Profile Baseline

- CONFORM TO ROCKDALE WATER RESOURCES WATER AND WASTEWATER STANDARDS AND SPECIFICATIONS, LATEST EDITION. CONTRACTOR WILL NOTIFY RUR ENGINEERING DEPARTMENT AT LEAST 12 HOURS
- PRIOR TO BEGINNING OF CONSTRUCTION ON WATER AND SEWER. AN INSPECTOR WILL BE ASSIGNED, AND A PRE-CONSTRUCTION MEETING SCHEDULED AT THIS
- AS-BUILT DRAWINGS SHALL BE FIELD VERIFIED AND STAMPED BY A REGISTERED PROFESSIONAL ENGINEER OR LAND SURVEYOR, LICENSED IN THE THE CONTRACTOR SHALL COMPLY WITH ALL UTILITIES PROTECTION CENTER

UTILITY LOCATION NOTES

- CONTRACTOR SHALL BE RESPONSIBLE TO SECURE THE SERVICES OF A PRIVATE UTILITY LOCATOR FIRM DURING THE ENTIRE COURSE OF CONSTRUCTION CONTRACTOR SHALL PAY FOR SAID SERVICES.
- CONTRACTOR SHALL IMMEDIATELY REPAIR ALL UTILITIES DAMAGED BY CONSTRUCTION ACTIVITIES, AT NO ADDITIONAL COST TO THE OWNER.
- THE UTILITIES SHOWN ARE SCHEMATIC AND FOR THE CONTRACTOR'S CONVENIENCE ONLY. THERE MAY BE OTHER UTILITIES NOT SHOWN ON THESE PLANS. THE DESIGN PROFESSIONAL ASSUMES NO RESPONSIBILITY FOR THE LOCATIONS SHOWN AND IT SHALL BE THE CONTRACTOR'S RESPONSIBILITY TO VERIFY THE LOCATIONS OF UTILITIES WITHIN THE LIMITS OF THE WORK. DAMAGE TO EXISTING UTILITIES BY THE CONTRACTOR, FROM HIS/ HER OPERATIONS SHALL BE IMMEDIATELY REPAIRED AT NO ADDITIONAL COST TO THE OWNER.
- CONTRACTOR SHALL BE RESPONSIBLE FOR COMPACTION OF BACKFILL OF ALL UTILITY TRENCHES WITHIN SITE WORK LIMITS. THIS INCLUDES TRENCHES DUG AND BACKFILLED BY LOCAL UTILITIES, SUCH AS POWER, GAS, TELEPHONE, ETC. CONTRACTOR SHALL PROVIDE ADDITIONAL BACKFILL AND COMPACTION AS NECESSARY, IF SETTLEMENT OCCURS.

GENERAL NOTES

P. NOTIFY ROCKDALE COUNTY'S INSPECTOR 24 HOURS PRIOR TO BEGINNING EVERY PHASE OF DEMOLITION.

3. HIGH INTENSITY LIGHTING FACILITIES SHALL BE SO ARRANGED THAT THE SOURCE OF ANY LIGHT IS CONCEALED FROM PUBLIC VIEW AND FROM ADJACENT RESIDENTIAL PROPERTY AND DOES NOT INTERFERE

4. ALL BUFFERS AND TREE SAVE AREAS SHALL BE CLEARLY IDENTIFIED BY FLAGGING AND FENCING PRIOR TO COMMENCEMENT OF ANY LAND DISTURBANCE

5. ACCESS TO SITE DURING CONSTRUCTION SHALL BE MAINTAINED AT ALL TIMES FOR EMERGENCY VEHICLES. 6. TEMPORARY SEDIMENT STORAGE FEATURES AND PERIMETER BMPS

SHALL BE CONSTRUCTED AND FULLY OPERATIONAL PRIOR TO ANY OTHER CONSTRUCTION OR GRADING. 1. NECESSARY BARRICADES, SUFFICIENT LIGHTS, SIGNS AND OTHER

TRAFFIC CONTROL METHODS AS MAY BE NECESSARY FOR THE PROTECTION AND SAFETY OF THE PUBLIC SHALL BE PROVIDED AND MAINTAINED THROUGHOUT CONSTRUCTION.

8. CUT AND FILL SLOPES SHALL NOT EXCEED TWO FEET (2') HORIZONTAL TO ONE FOOT (I') VERTICAL.

9. ANY DISCREPANCY FOUND BETWEEN SHEETS IN THIS SET SHALL BE REFERRED TO THE OWNERS REPRESENTATIVE AND SITE DESIGN PROFESSIONAL FOR CLARIFICATION PRIOR TO PROCEEDING WITH ANY CONSTRUCTION ACTIVITY

0. CONTRACTOR SHALL VERIFY ALL BENCH MARKS AND EXISTING SITE CONDITIONS PRIOR TO PROCEEDING WITH DEMOLITION ACTIVITY. I. TOPSOIL SHALL BE STRIPPED AND STOCKPILED ON-SITE. NO TOPSOIL SHALL BE REMOVED FROM SITE.

2. ALL CONSTRUCTION SHALL COMPLY WITH ALL APPLICABLE FEDERAL, STATE, COUNTY AND LOCAL CODES AND MINIMUM STANDARDS AND SPECIFICATIONS.

3. ALL NECESSARY LICENSES AND PERMITS SHALL BE OBTAINED BY THE CONTRACTOR.

14. ALL GRADES SHOWN ARE FINISHED GRADES. CONTRACTOR SHALL VERIFY ALL DIMENSIONS AND GRADES. 5. TREES TO BE SAVED SHALL BE PROTECTED BY THE

6. CONTRACTOR SHALL BE RESPONSIBLE FOR RELOCATING EXISTING UTILITIES IDENTIFIED ON THESE PLANS AT NO ADDITIONAL COST TO

17. IT IS THE CONTRACTOR'S RESPONSIBILITY TO BE IN COMPLIANCE WITH APPLICABLE N.P.D.E.S. PERMITS AND CLEAN WATER ACT REQUIREMENTS. CONTRACTOR SHALL BE RESPONSIBLE AS THE

18. COMPACTION OF BACKFILL SHALL BE PER ROCKDALE COUNTY

19. THERE SHALL BE NO BURIAL OF CONSTRUCTION DEBRIS OR DRGANICS ON THIS SITE, CONTRACTOR SHALL DISPOSE OF DEBRIS IN A MANNER THAT MEETS ALL FEDERAL, STATE, COUNTY, AND LOCAL REGULATIONS SET FORTH BY THE GOVERNING AGENCY.

20. APPROVAL OF THESE PLANS DOES NOT CONSTITUTE APPROVAL BY ROCKDALE COUNTY OF ANY LAND DISTURBING ACTIVITIES WITHIN WETLAND AREAS. IT IS THE RESPONSIBILITY OF THE PROPERTY OWNER TO CONTACT THE APPROPRIATE REGULATORY AGENCY FOR APPROVAL OF ANY WETLAND AREA DISTURBANCE.

21. ALL CONSTRUCTION TO COMPLY WITH ROCKDALE COUNTY STANDARDS.

LAYOUT & STAKING SITE UTILITIES ----W--- DOMESTIC WATER FH FIRE HYDRANT DETAIL REFERENCE (SHEET* PIVO POST INDICATOR VALVE TB CONCRETE THRUST BLOCKING G.DO.T. TYPE 4010 VEHICULAR GUARDRAI WV ₩ WATER VALVE **PAVEMENT MARKINGS** - S - GRAVITY SANITARY SEWER PARKING ARROW - STRAIGHT, WHITE **GENERAI** PAINTED CROSSWALK - WHITE -TP-TREE PROTECTION FENCE ADA PARKING ACCESS AISLE - BLUE ---- LIMITS OF CONSTRUCTION PAINTED WORD "STOP" - WHITE EXISTING TREE TO BE REMOVED PAINTED WORD "ONLY" - WHITE STORM DRAINAGE SIGNAGE STORM STRUCTURE LABEL HEADWALL STOP SIGN - MUTCD STANDARD RI-1 FLARED END SECTION - GDOT **FE**6 STANDARD 1122 SAFETY END SECTION - GDOT YIELD SIGN - MUTCD STANDARD RI-2 STANDARD 1122 CATCH BASIN / GRATE INLET NO PARKING SIGN - MUTCD STANDARD R8-3a JUNCTION BOX DROP INLET - PEDESTAL TOP OO NOT ENTER SIGN - MUTCD STANDARD R5-CURB INLET - GDOT STANDARD 10/19a / TYPE 'E' HOOD ONE WAY SIGN - MUTCO STANDARD R6-2 SWCB SINGLE-WING CATCH BASIN -DOT STANDARD 1033D DOUBLE-WING CATCH BASIN - GDOT SITE GRADING STANDARD 1034D OUTLET CONTROL STRUCTURE 52 PROPOSED INTERMEDIATE CONTOURS TOP OF STRUCTURE ELEVATION TSO PROPOSED INDEX CONTOURS THROAT OF STRUCTURE ELEVATION HIGH-DENSITY POLYETHYLENE PIPE ALUMINIZED STEEL TYPE 2 PIPE +H.P. HIGH POINT 4ST2 SPIRAL RIB CMP (MANNING'S =0.012, ULTRAFLOW (TM) OR +L.P. LOW POINT APPROVED EQUAL DUCTILE IRON PIPE REINFORCED CONCRETE PIPE (CLASS Y OR Y) W/ RUBBER O-RING GASKET POLYVINYL CHLORIDE PIPE SLOPE INDICATOR (H:V) SCHEDULE 40) +TW 50.5 FINISHED GRADE AT TOP OF WALL NVERT ELEVATION - IN INVERT ELEVATION - OUT +BW 50.5 FINISHED GRADE AT BOTTOM OF WALL INY. OUT HYDRAULIC GRADE LINE +TC 50.5 TOP OF CURB ELEVATION

SITE PLAN LEGENDS

6 7 **PROJECT DATA** SW HIGHWAY 212, CONYERS, GA 30012 TAX PARCELS: Ø13ØØ1Ø29B LAND LOTS: 213 4 236 ZONING: EXISTING USE: UNDEVELOPED FIRE TRAINING CAMPUS PROPOSED USE: TOTAL AREA OF SITE: 72.45 ACRES DISTURBED AREA: 815 ACRES EXISTING IMPERVIOUS 0.00 ACRES IMPERVIOUS AREA: LOCAL ISSUING AUTHORITY: ROCKDALE COUNTY (LDP) PERMIT NUMBER: SEWER AUTHORITY ROCKDALE COUNTY

ROCKDALE COUNTY

PERMIT NUMBER:

WATER AUTHORITY

www.Georgia811.com

SHEET#

CO.00

C0.10

C0.20

C1.00

C1.50

C2.00

C3.00

C3.05

C3.10

C4.00

C4.20

C4.30

C4.40

C5.00

C5.05

C7.00

GEORGIA LAW MANDATES THAT, BEFORE BEGINNING ANY MECHANIZED DIGGING OR EXCAYATION WORK, YOU MUST CONTACT GEORGIA 811 BY USING EREQUEST ON WWW.GEORGIASII.COM OR BY CALLING 811 OR 1-800-282-7411 AT LEAST 48 HOURS BUT NO MORE THAN 10 WORKING DAYS IN ADVANCE TO HAVE UTILITY LINES MARKED.

SHEET INDEX

TOPOGRAPHIC SURVEY 1 OF 2

TOPOGRAPHIC SURVEY 2 OF 2

DEMOLITION & REMOVAL PLAN

ES&PC PLAN - PERIMETER PHASE

ES&PC PLAN - INTERMEDIATE PHASE

SITE WORK CONSTRUCTION DETAILS

SITE WORK CONSTRUCTION DETAILS

24-HOUR EROSION CONTACT 4

ROCKDALE COUNTY STANDARD DETAILS

ROCKDALE COUNTY STANDARD DETAILS

ES&PC PLAN - INITIAL PHASE

ES&PC PLAN - FINAL PHASE

GRADING & DRAINAGE PLAN ROADWAY

STAKING & LAYOUT PLAN

STORM DRAINAGE PLAN

SHEET NAME

COVER SHEET

MASTER PLAN

GRADING PLAN

PIPE PROFILES

NPDES NOTES

NPDES NOTES

ES&PC DETAILS

ES&PC DETAILS

ES&PC DETAILS

WATER LINE PLAN

TREE PROTECTION PLAN

UTILITY PLAN

ROCKDALE COUNTY BOC

CALL BEFORE YOU DIG

PHONE NUMBER: 678-387-7081

EMAIL ADDRESS: ANDREW.HAMMER@ROCKDALECOUNTYGA.GOV

DO NOT BREAK OR DUPLICATE

DO NOT DUPLICATE DRAWINGS WITHOUT PERMISSION.

READ THE SPECIFICATIONS. THIS SET OF DRAWINGS AND SPECIFICATIONS DEFINE PROJECT SCOPE AND CONTRACT REQUIREMENTS. INDIVIDUAL SHEETS SEPARATED FROM THE SET MAY NOT ADEQUATELY REFLECT ALL INFORMATION NEEDED TO SUITABLY COVER CERTAIN ITEMS. DO NO SEPARATE THIS SET OF DRAWINGS INTO INDIVIDUAL SHEETS



Cumming, GA 30040

7-DAY LETTER CERTIFICATION

THE BELOW SIGNATURE VERIFIES THAT A 1-DAY LETTER WILL BE CERTIFIED UPON COMPLETION OF THE INITIAL INSPECTION PER NPDES REQUIREMENTS.



CERTIFIED DESIGN PROFESSIONAL: JUSTIN M TANNER GSWCC CERTIFICATION NO. LEVEL 11 * 0000029448 EXPIRATION DATE: Ø3-29-2Ø24 COMPANY: BREEDLOVE LAND PLANNING, INC.

PAVING LEGEND



HEAVY DUTY ASPHALT




CONCRETE PAYING

GENERAL LAYOUT NOTES

- PROPOSED BUILDING USE: FIRE TRAINING FACILITY
- CONTRACTOR SHALL VERIFY CONDITIONS AND DIMENSIONS BEFORE PROCEEDING WITH CONSTRUCTION. ANY DISCREPANCIES FOUND SHALL BE REPORTED TO THE ARCHITECT FOR CLARIFICATION AND/OR CORRECTION BEFORE PROCEEDING WITH THE WORK. CONTRACTOR SHALL ASSUME RESPONSIBILITY FOR DISCREPANCIES WHICH ARE NOT REPORTED.
- CONTRACTOR SHALL STAKE ALL BUILDING CORNERS AND OBTAIN ARCHITECTS APPROVAL BEFORE POURING ANY FOOTINGS.
- 4. REFER TO ARCHITECTURAL PLANS FOR ACTUAL BUILDING DIMENSIONS.
- 5. ALL DIMENSIONS ARE TO THE FACE OF CURBS AND FACE OF WALLS.
- 6. ALL ANGLES ARE 90° UNLESS OTHERWISE NOTED.
- CURB AND GUTTER RADII ARE 5' UNLESS OTHERWISE NOTED.

GRAPHIC SCALE & ORIENTATION

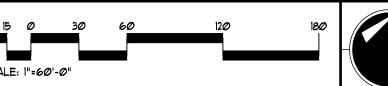


- CONTRACTOR SHALL BE RESPONSIBLE TO SECURE THE SERVICES OF A PRIVATE UTILITY LOCATOR FIRM DURING THE ENTIRE COURSE OF CONSTRUCTION.
- CONTRACTOR SHALL IMMEDIATELY REPAIR ALL UTILITIES DAMAGED BY CONSTRUCTION ACTIVITIES, AT NO ADDITIONAL COST TO THE OWNER.
- CONTRACTOR SHALL PROVIDE ADDITIONAL BACKFILL AND COMPACTION AS NECESSARY, IF SETTLEMENT OCCURS.



GEORGIA LAW MANDATES THAT, BEFORE BEGINNING ANY MECHANIZED DIGGING OR EXCAVATION WORK, YOU MUST CONTACT GEORGIA 811 BY USING EREQUEST ON WWW.GEORGIA811.COM OR BY CALLING 811 OR 1-800-282-7411 AT LEAST 48 HOURS BUT NO MORE THAN 10 WORKING DAYS IN ADVANCE TO HAVE UTILITY LINES MARKED.

1. DO NOT DUPLICATE DRAWINGS WITHOUT PERMISSION.

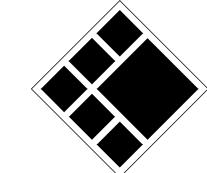


BREEDLOVE LAND PLANNING Landscape Architects ◆ Civil Engineers 15 Simpson Street, NW, Atlanta, GA 30308 P: 770-483-1173 ◆ www.landplanning.net

BLP PROJ. NO. 22158



24-HOUR EROSION CONTACT

ANDREW HAMMER ROCKDALE COUNTY BOC COMPANY: EMAIL ADDRESS: ANDREW.HAMMER@ROCKDALECOUNTYGAGOV

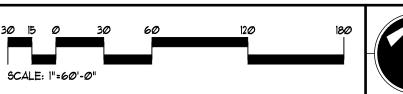

UTILITY LOCATION NOTES

- CONTRACTOR SHALL PAY FOR SAID SERVICES.
- THE UTILITIES SHOWN ARE SCHEMATIC AND FOR THE CONTRACTOR'S CONVENIENCE ONLY. THERE MAY BE OTHER UTILITIES NOT SHOWN ON THESE PLANS. THE DESIGN PROFESSIONAL ASSUMES NO RESPONSIBILITY FOR THE LOCATIONS SHOWN AND IT SHALL BE THE CONTRACTOR'S RESPONSIBILITY TO VERIFY THE LOCATIONS OF UTILITIES WITHIN THE LIMITS OF THE WORK. DAMAGE TO EXISTING UTILITIES BY THE CONTRACTOR, FROM HIS/ HER OPERATIONS SHALL BE IMMEDIATELY REPAIRED AT NO ADDITIONAL COST TO THE OWNER.
- CONTRACTOR SHALL BE RESPONSIBLE FOR COMPACTION OF BACKFILL OF ALL UTILITY TRENCHES WITHIN SITE WORK LIMITS. THIS INCLUDES TRENCHES DUG AND BACKFILLED BY LOCAL UTILITIES, SUCH AS POWER, GAS, TELEPHONE, ETC.

CALL BEFORE YOU DIG



DO NOT BREAK OR DUPLICATE

- READ THE SPECIFICATIONS. THIS SET OF DRAWINGS AND SPECIFICATIONS DEFINE PROJECT SCOPE AND CONTRACT REQUIREMENTS. INDIVIDUAL SHEETS SEPARATED FROM THE SET MAY NOT ADEQUATELY REFLECT ALL INFORMATION NEEDED TO SUITABLY COVER CERTAIN ITEMS. DO NO SEPARATE THIS SET OF DRAWINGS INTO INDIVIDUAL SHEETS.

PRINT RECORD

PKI	PRINT RECORD				
No.	DATE	DESCRIPTION			
1	07/31/2023	LDP SUBMITTAL			
2	09/07/2023	LDP RESUBMITTAL			
3	10/12/2023	LDP RESUBMITTAL			
4	01/16/2024	LDP RESUBMITTAL			


ROCKDALE COUNT COMMISSIONERS

Drawn By Checked By Date Job No. 05/05/2023

Sheet Title


STAKING AND LAYOUT PLAN

Sheet No.

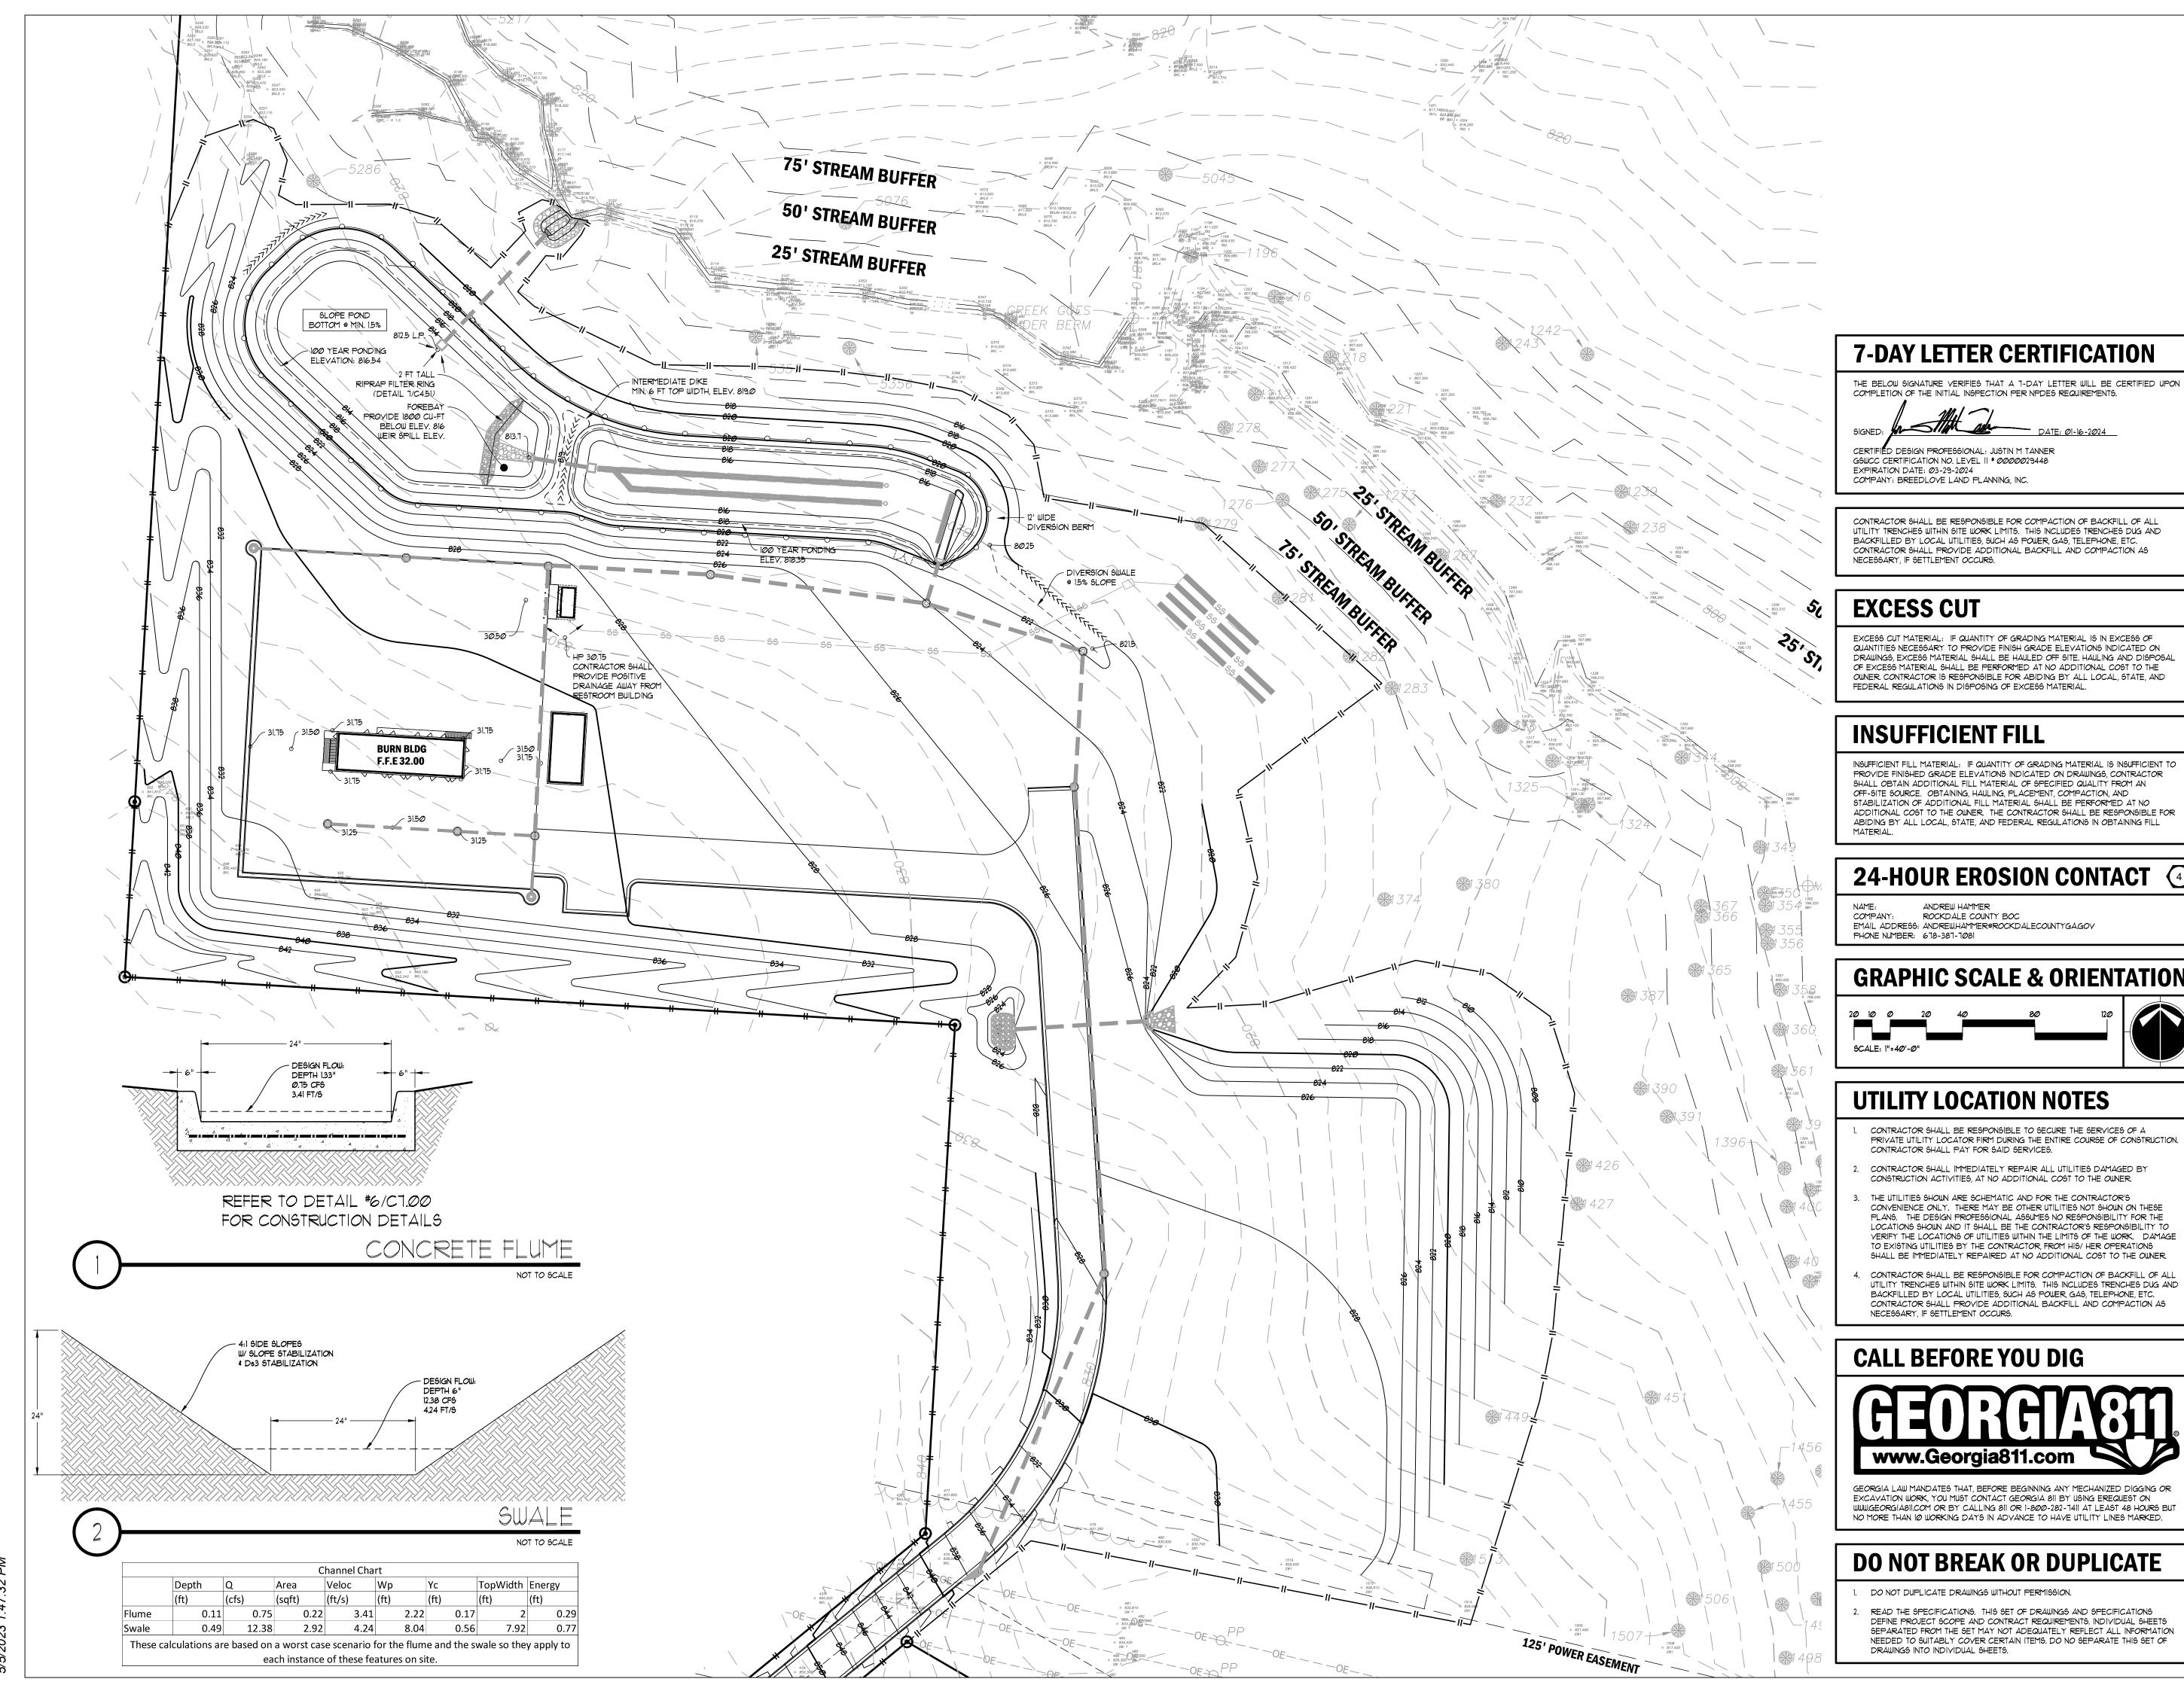




208 Pirkle Ferry Road, Suite C Cumming, GA 30040

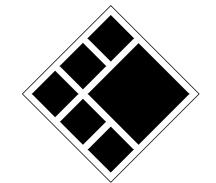

BREEDLOVE LAND PLANNING Landscape Architects ◆ Civil Engineers 15 Simpson Street, NW, Atlanta, GA 30308 P: 770-483-1173 ◆ www.landplanning.net

BLP PROJ. NO. 22158

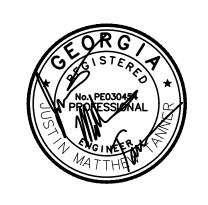

INSUFFICIENT FILL

CERTIFIED DESIGN PROFESSIONAL: JUSTIN M TANNER

COMPANY: BREEDLOVE LAND PLANNING, INC.

INSUFFICIENT FILL MATERIAL: IF QUANTITY OF GRADING MATERIAL IS INSUFFICIENT TO PROVIDE FINISHED GRADE ELEVATIONS INDICATED ON DRAWINGS, CONTRACTOR SHALL OBTAIN ADDITIONAL FILL MATERIAL OF SPECIFIED QUALITY FROM AN OFF-SITE SOURCE. OBTAINING, HAULING, PLACEMENT, COMPACTION, AND STABILIZATION OF ADDITIONAL FILL MATERIAL SHALL BE PERFORMED AT NO ADDITIONAL COST TO THE OWNER. THE CONTRACTOR SHALL BE RESPONSIBLE FOR ABIDING BY ALL LOCAL, STATE, AND FEDERAL REGULATIONS IN OBTAINING FILL

DRAWINGS, EXCESS MATERIAL SHALL BE HAULED OFF SITE. HAULING AND DISPOSAL

OUNER CONTRACTOR IS RESPONSIBLE FOR ABIDING BY ALL LOCAL, STATE, AND

CONTRACTOR SHALL BE RESPONSIBLE FOR COMPACTION OF BACKFILL OF ALL

UTILITY TRENCHES WITHIN SITE WORK LIMITS. THIS INCLUDES TRENCHES DUG AND

24-HOUR EROSION CONTACT

ANDREW HAMMER ROCKDALE COUNTY BOC COMPANY: EMAIL ADDRESS: ANDREW.HAMMER@ROCKDALECOUNTYGAGOV

PHONE NUMBER: 678-387-7081

GRAPHIC SCALE & ORIENTATION



UTILITY LOCATION NOTES

- CONTRACTOR SHALL BE RESPONSIBLE TO SECURE THE SERVICES OF A PRIVATE UTILITY LOCATOR FIRM DURING THE ENTIRE COURSE OF CONSTRUCTION. CONTRACTOR SHALL PAY FOR SAID SERVICES.
- CONTRACTOR SHALL IMMEDIATELY REPAIR ALL UTILITIES DAMAGED BY CONSTRUCTION ACTIVITIES, AT NO ADDITIONAL COST TO THE OWNER.
- THE UTILITIES SHOWN ARE SCHEMATIC AND FOR THE CONTRACTOR'S CONVENIENCE ONLY. THERE MAY BE OTHER UTILITIES NOT SHOWN ON THESE PLANS. THE DESIGN PROFESSIONAL ASSUMES NO RESPONSIBILITY FOR THE LOCATIONS SHOWN AND IT SHALL BE THE CONTRACTOR'S RESPONSIBILITY TO VERIFY THE LOCATIONS OF UTILITIES WITHIN THE LIMITS OF THE WORK. DAMAGE TO EXISTING UTILITIES BY THE CONTRACTOR, FROM HIS/ HER OPERATIONS SHALL BE IMMEDIATELY REPAIRED AT NO ADDITIONAL COST TO THE OWNER.
- CONTRACTOR SHALL BE RESPONSIBLE FOR COMPACTION OF BACKFILL OF ALL UTILITY TRENCHES WITHIN SITE WORK LIMITS. THIS INCLUDES TRENCHES DUG AND BACKFILLED BY LOCAL UTILITIES, SUCH AS POWER, GAS, TELEPHONE, ETC. CONTRACTOR SHALL PROVIDE ADDITIONAL BACKFILL AND COMPACTION AS NECESSARY, IF SETTLEMENT OCCURS.

CALL BEFORE YOU DIG



GEORGIA LAW MANDATES THAT, BEFORE BEGINNING ANY MECHANIZED DIGGING OR EXCAVATION WORK, YOU MUST CONTACT GEORGIA 811 BY USING EREQUEST ON WWW.GEORGIA811.COM OR BY CALLING 811 OR 1-800-282-7411 AT LEAST 48 HOURS BUT NO MORE THAN 10 WORKING DAYS IN ADVANCE TO HAVE UTILITY LINES MARKED.

DO NOT BREAK OR DUPLICATE

- 1. DO NOT DUPLICATE DRAWINGS WITHOUT PERMISSION.
- READ THE SPECIFICATIONS. THIS SET OF DRAWINGS AND SPECIFICATIONS DEFINE PROJECT SCOPE AND CONTRACT REQUIREMENTS. INDIVIDUAL SHEETS SEPARATED FROM THE SET MAY NOT ADEQUATELY REFLECT ALL INFORMATION NEEDED TO SUITABLY COVER CERTAIN ITEMS. DO NO SEPARATE THIS SET OF DRAWINGS INTO INDIVIDUAL SHEETS.

COUNT ROCKDALE (TRAIINNG CA

PRINT RECORD			
No.	DATE	DESCRIPTION	
1	07/31/2023	LDP SUBMITTAL	
2	09/07/2023	LDP RESUBMITTAL	
3	10/12/2023	LDP RESUBMITTAL	
4	01/16/2024	LDP RESUBMITTAL	

ROCKDALE COUNTONING COMMISSIONERS


Drawn By	Checked By BAM
Date	Job No.
05/05/2023	22051

GRADING PLAN

Sheet No.

Sheet Title



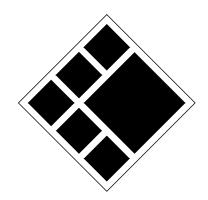

BREEDLOVE LAND PLANNING Landscape Architects ◆ Civil Engineers 15 Simpson Street, NW, Atlanta, GA 30308 P: 770-483-1173 ◆ www.landplanning.net

BLP PROJ. NO. 22158



NOTE:

CONTRACTOR SHALL PROVIDE POSITIVE DRAINAGE AWAY FROM ALL BUILDINGS. DEVELOPER IS TO CLEAN OUT ACCUMULATED SILT IN DETENTION POND AT END OF CONSTRUCTION WHEN DISTURBED AREAS HAVE BEEN STABILIZED. REGULAR MAINTENANCE SHALL BE THE RESPONSIBILITY OF THE COUNTY.

CONTRACTOR SHALL CONSTRUCT THE DETENTION BASIN WITHIN <u>CALENDAR</u>

<u>DAYS</u> OF ARRIVAL ON SITE WITH CONSTRUCTION EQUIPMENT. THIS INCLUDES COMPLETE GRADING, STORM PIPE SYSTEM, INSTALLATION OF GRASSING, EROSION CONTROL BLANKETS AND TREE PLANTINGS.

24-HOUR EROSION CONTACT

ANDREW HAMMER ROCKDALE COUNTY BOC COMPANY: EMAIL ADDRESS: ANDREW.HAMMER@ROCKDALECOUNTYGA.GOV

GRAPHIC SCALE & ORIENTATION



UTILITY LOCATION NOTES

- CONTRACTOR SHALL BE RESPONSIBLE TO SECURE THE SERVICES OF A PRIVATE UTILITY LOCATOR FIRM DURING THE ENTIRE COURSE OF CONSTRUCTION. CONTRACTOR SHALL PAY FOR SAID SERVICES.
 - CONTRACTOR SHALL IMMEDIATELY REPAIR ALL UTILITIES DAMAGED BY CONSTRUCTION ACTIVITIES, AT NO ADDITIONAL COST TO THE OWNER.
- THE UTILITIES SHOWN ARE SCHEMATIC AND FOR THE CONTRACTOR'S CONVENIENCE ONLY. THERE MAY BE OTHER UTILITIES NOT SHOWN ON THESE PLANS. THE DESIGN PROFESSIONAL ASSUMES NO RESPONSIBILITY FOR THE LOCATIONS SHOWN AND IT SHALL BE THE CONTRACTOR'S RESPONSIBILITY TO VERIFY THE LOCATIONS OF UTILITIES WITHIN THE LIMITS OF THE WORK. DAMAGE TO EXISTING UTILITIES BY THE CONTRACTOR, FROM HIS/ HER OPERATIONS SHALL BE IMMEDIATELY REPAIRED AT NO ADDITIONAL COST TO THE OWNER.
- CONTRACTOR SHALL BE RESPONSIBLE FOR COMPACTION OF BACKFILL OF ALL UTILITY TRENCHES WITHIN SITE WORK LIMITS. THIS INCLUDES TRENCHES DUG AND BACKFILLED BY LOCAL UTILITIES, SUCH AS POWER, GAS, TELEPHONE, ETC. CONTRACTOR SHALL PROVIDE ADDITIONAL BACKFILL AND COMPACTION AS NECESSARY, IF SETTLEMENT OCCURS.

CALL BEFORE YOU DIG



GEORGIA LAW MANDATES THAT, BEFORE BEGINNING ANY MECHANIZED DIGGING OR EXCAVATION WORK, YOU MUST CONTACT GEORGIA 811 BY USING EREQUEST ON WWW.GEORGIA811.COM OR BY CALLING 811 OR 1-800-282-7411 AT LEAST 48 HOURS BUT NO MORE THAN 10 WORKING DAYS IN ADVANCE TO HAVE UTILITY LINES MARKED.

DO NOT BREAK OR DUPLICATE

- 1. DO NOT DUPLICATE DRAWINGS WITHOUT PERMISSION.
- READ THE SPECIFICATIONS. THIS SET OF DRAWINGS AND SPECIFICATIONS DEFINE PROJECT SCOPE AND CONTRACT REQUIREMENTS. INDIVIDUAL SHEETS SEPARATED FROM THE SET MAY NOT ADEQUATELY REFLECT ALL INFORMATION NEEDED TO SUITABLY COVER CERTAIN ITEMS. DO NO SEPARATE THIS SET OF DRAWINGS INTO INDIVIDUAL SHEETS.

PRI	PRINT RECORD				
No.	DATE	DESCRIPTION			
1	07/31/2023	LDP SUBMITTAL			
2	09/07/2023	LDP RESUBMITTAL			
3	10/12/2023	LDP RESUBMITTAL			
4	01/16/2024	LDP RESUBMITTAL			

ROCKDALE COUN COMMISSIONERS

Drawn By **Checked By** Date Job No.

05/05/2023 **Sheet Title**

STORM DRAINAGE

Sheet No.

COMPANY: BREEDLOVE LAND PLANNING, INC.

DISTURBED AREA

TOTAL SITE AREA: 12.45 AC DISTURBED AREA: 0.66 AC

GENERAL EROSION NOTES

NOTIFY CITY/COUNTY INSPECTORS 24 HOURS BEFORE BEGINNING OF EVERY CONSTRUCTION PHASE.

- ALL BUFFERS AND TREE SAVE AREAS SHALL BE CLEARLY IDENTIFIED BY FLAGGING AND/OR FENCING PRIOR TO COMMENCEMENT OF ANY LAND
- THE INSTALLATION OF EROSION AND SEDIMENTATION CONTROL MEASURES AND PRACTICES SHALL OCCUR PRIOR TO OR CONCURRENT WITH LAND DISTURBING ACTIVITIES AND CONSTRUCTION ON THE SITE AND MAINTAINED UNTIL PERMANENT GROUNDCOVER IS ESTABLISHED.
- ALL SEDIMENT BARRIERS SHALL BE INSTALLED PRIOR TO ANY GRADING.
- SEDIMENT BARRIER DEVICES SHALL BE INSPECTED AND REPAIRED OF DAMAGE DAILY. ANY ACCUMULATED SEDIMENT SHALL BE REMOVED AND SPREAD ON SITE.
- ALL DISTURBED AREAS SHALL BE GRASSED AS SOON AS CONSTRUCTION
- EROSION AND SEDIMENTATION CONTROL MEASURES SHALL BE MAINTAINED AT ALL TIMES. ADDITIONAL EROSION AND SEDIMENTATION CONTROL MEASURES SHALL BE INSTALLED IF DEEMED NECESSARY BY ON-SITE INSPECTION OR AS REQUIRED BY CITY/COUNTY AT NO ADDITIONAL COST TO THE OWNER.
- MAINTENANCE OF ALL SOIL EROSION AND SEDIMENTATION CONTROL MEASURES AND PRACTICES, WHETHER TEMPORARY OF PERMANENT, SHALL BE THE RESPONSIBILITY OF THE CONTRACTOR/OWNER.
- ANY DISCREPANCY BETWEEN THIS SHEET AND OTHERS IN THIS SET SHALL BE REFERRED TO THE ARCHITECT BY THE CONTRACTOR FOR CLARIFICATION BEFORE PROCEEDING WITH THE WORK.
- 10. SEDIMENT STORAGE LEVEL MARKERS MUST BE INSTALLED IN SEDIMENT STORAGE STRUCTURES, INDICATING THE 1/3 FULL VOLUME.
- MAXIMUM CUT OR FILL SLOPE 15 (2:1) 2' HORIZONTAL TO 1' VERTICAL.
- CONTRACTOR SHALL PROVIDE TEMPORARY DOWN DRAINS ON FILL SLOPES TO PREVENT EROSION PRIOR TO STABILIZATION.
- 13. CONTRACTOR SHALL REMOVE ACCUMULATED SEDIMENT FROM DETENTION BASIN AT END OF CONSTRUCTION WHEN ALL DISTURBED AREAS HAVE BEEN FULLY
- 14. THE ESCAPE OF SEDIMENT FROM THE SITE SHALL BE PREVENTED BY THE INSTALLATION OF EROSION AND SEDIMENT CONTROL MEASURES AND PRACTICES PRIOR TO LAND DISTURBING ACTIVITIES.
- EROSION CONTROL MEASURES WILL BE MAINTAINED AT ALL TIMES. IF FULL IMPLEMENTATION OF THE APPROVED PLAN DOES NOT PROVIDE FOR EFFECTIVE EROSION CONTROL, ADDITIONAL EROSION AND SEDIMENT CONTROL MEASURES SHALL BE IMPLEMENTED TO CONTROL OR TREAT THE SEDIMENT SOURCE AT NO ADDITIONAL COST TO THE OWNER.
- ANY DISTURBED AREA LEFT EXPOSED FOR A PERIOD GREATER THAN 14 DAYS SHALL BE STABILIZED WITH MULCH OR TEMPORARY SEEDING.

24-HOUR EROSION CONTACT

COMPANY:

GRAPHIC SCALE & ORIENTATION

UTILITY LOCATION NOTES

- CONTRACTOR SHALL BE RESPONSIBLE TO SECURE THE SERVICES OF A PRIVATE UTILITY LOCATOR FIRM DURING THE ENTIRE COURSE OF CONSTRUCTION.
- CONTRACTOR SHALL IMMEDIATELY REPAIR ALL UTILITIES DAMAGED BY CONSTRUCTION ACTIVITIES, AT NO ADDITIONAL COST TO THE OWNER.
- CONTRACTOR SHALL BE RESPONSIBLE FOR COMPACTION OF BACKFILL OF ALL BACKFILLED BY LOCAL UTILITIES, SUCH AS POWER, GAS, TELEPHONE, ETC. CONTRACTOR SHALL PROVIDE ADDITIONAL BACKFILL AND COMPACTION AS NECESSARY, IF SETTLEMENT OCCURS.




GEORGIA LAW MANDATES THAT, BEFORE BEGINNING ANY MECHANIZED DIGGING OR NO MORE THAN 10 WORKING DAYS IN ADVANCE TO HAVE UTILITY LINES MARKED.

DO NOT BREAK OR DUPLICATE

READ THE SPECIFICATIONS. THIS SET OF DRAWINGS AND SPECIFICATIONS DEFINE PROJECT SCOPE AND CONTRACT REQUIREMENTS. INDIVIDUAL SHEETS SEPARATED FROM THE SET MAY NOT ADEQUATELY REFLECT ALL INFORMATION NEEDED TO SUITABLY COVER CERTAIN ITEMS. DO NO SEPARATE THIS SET OF DRAWINGS INTO INDIVIDUAL SHEETS.



208 Pirkle Ferry Road, Suite C Cumming, GA 30040

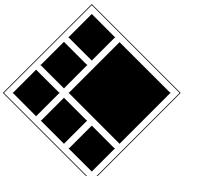


BREEDLOVE LAND PLANNING Landscape Architects ◆ Civil Engineers 15 Simpson Street, NW, Atlanta, GA 30308 P: 770-483-1173 ◆ www.landplanning.net

BLP PROJ. NO. 22158



ANDREW HAMMER ROCKDALE COUNTY BOC EMAIL ADDRESS: ANDREWHAMMER®ROCKDALECOUNTYGA.GOV PHONE NUMBER: 618-381-1081

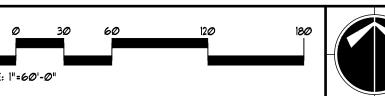

- CONTRACTOR SHALL PAY FOR SAID SERVICES.
- THE UTILITIES SHOWN ARE SCHEMATIC AND FOR THE CONTRACTOR'S CONVENIENCE ONLY. THERE MAY BE OTHER UTILITIES NOT SHOWN ON THESE PLANS. THE DESIGN PROFESSIONAL ASSUMES NO RESPONSIBILITY FOR THE LOCATIONS SHOWN AND IT SHALL BE THE CONTRACTOR'S RESPONSIBILITY TO VERIFY THE LOCATIONS OF UTILITIES WITHIN THE LIMITS OF THE WORK. DAMAGE TO EXISTING UTILITIES BY THE CONTRACTOR, FROM HIS/ HER OPERATIONS SHALL BE IMMEDIATELY REPAIRED AT NO ADDITIONAL COST TO THE OWNER
- UTILITY TRENCHES WITHIN SITE WORK LIMITS. THIS INCLUDES TRENCHES DUG AND

CALL BEFORE YOU DIG



EXCAYATION WORK, YOU MUST CONTACT GEORGIA 811 BY USING EREQUEST ON WWW.GEORGIA811.COM OR BY CALLING 811 OR 1-800-282-7411 AT LEAST 48 HOURS BUT

DO NOT DUPLICATE DRAWINGS WITHOUT PERMISSION.

2 12 13

COMPANY: BREEDLOVE LAND PLANNING, INC.

PRINT RECORD

No. DATE

1 07/31/2023

2 09/07/2023

3 10/12/2023

4 01/16/2024

ROCKDALE COUN COMMISSIONERS

DESCRIPTION

LDP SUBMITTAL

LDP RESUBMITTAL

LDP RESUBMITTAL


LDP RESUBMITTAL

Drawn By Checked By Date Job No.

Sheet Title ES&PC PLAN -

PERIMETER PHASE

Sheet No.

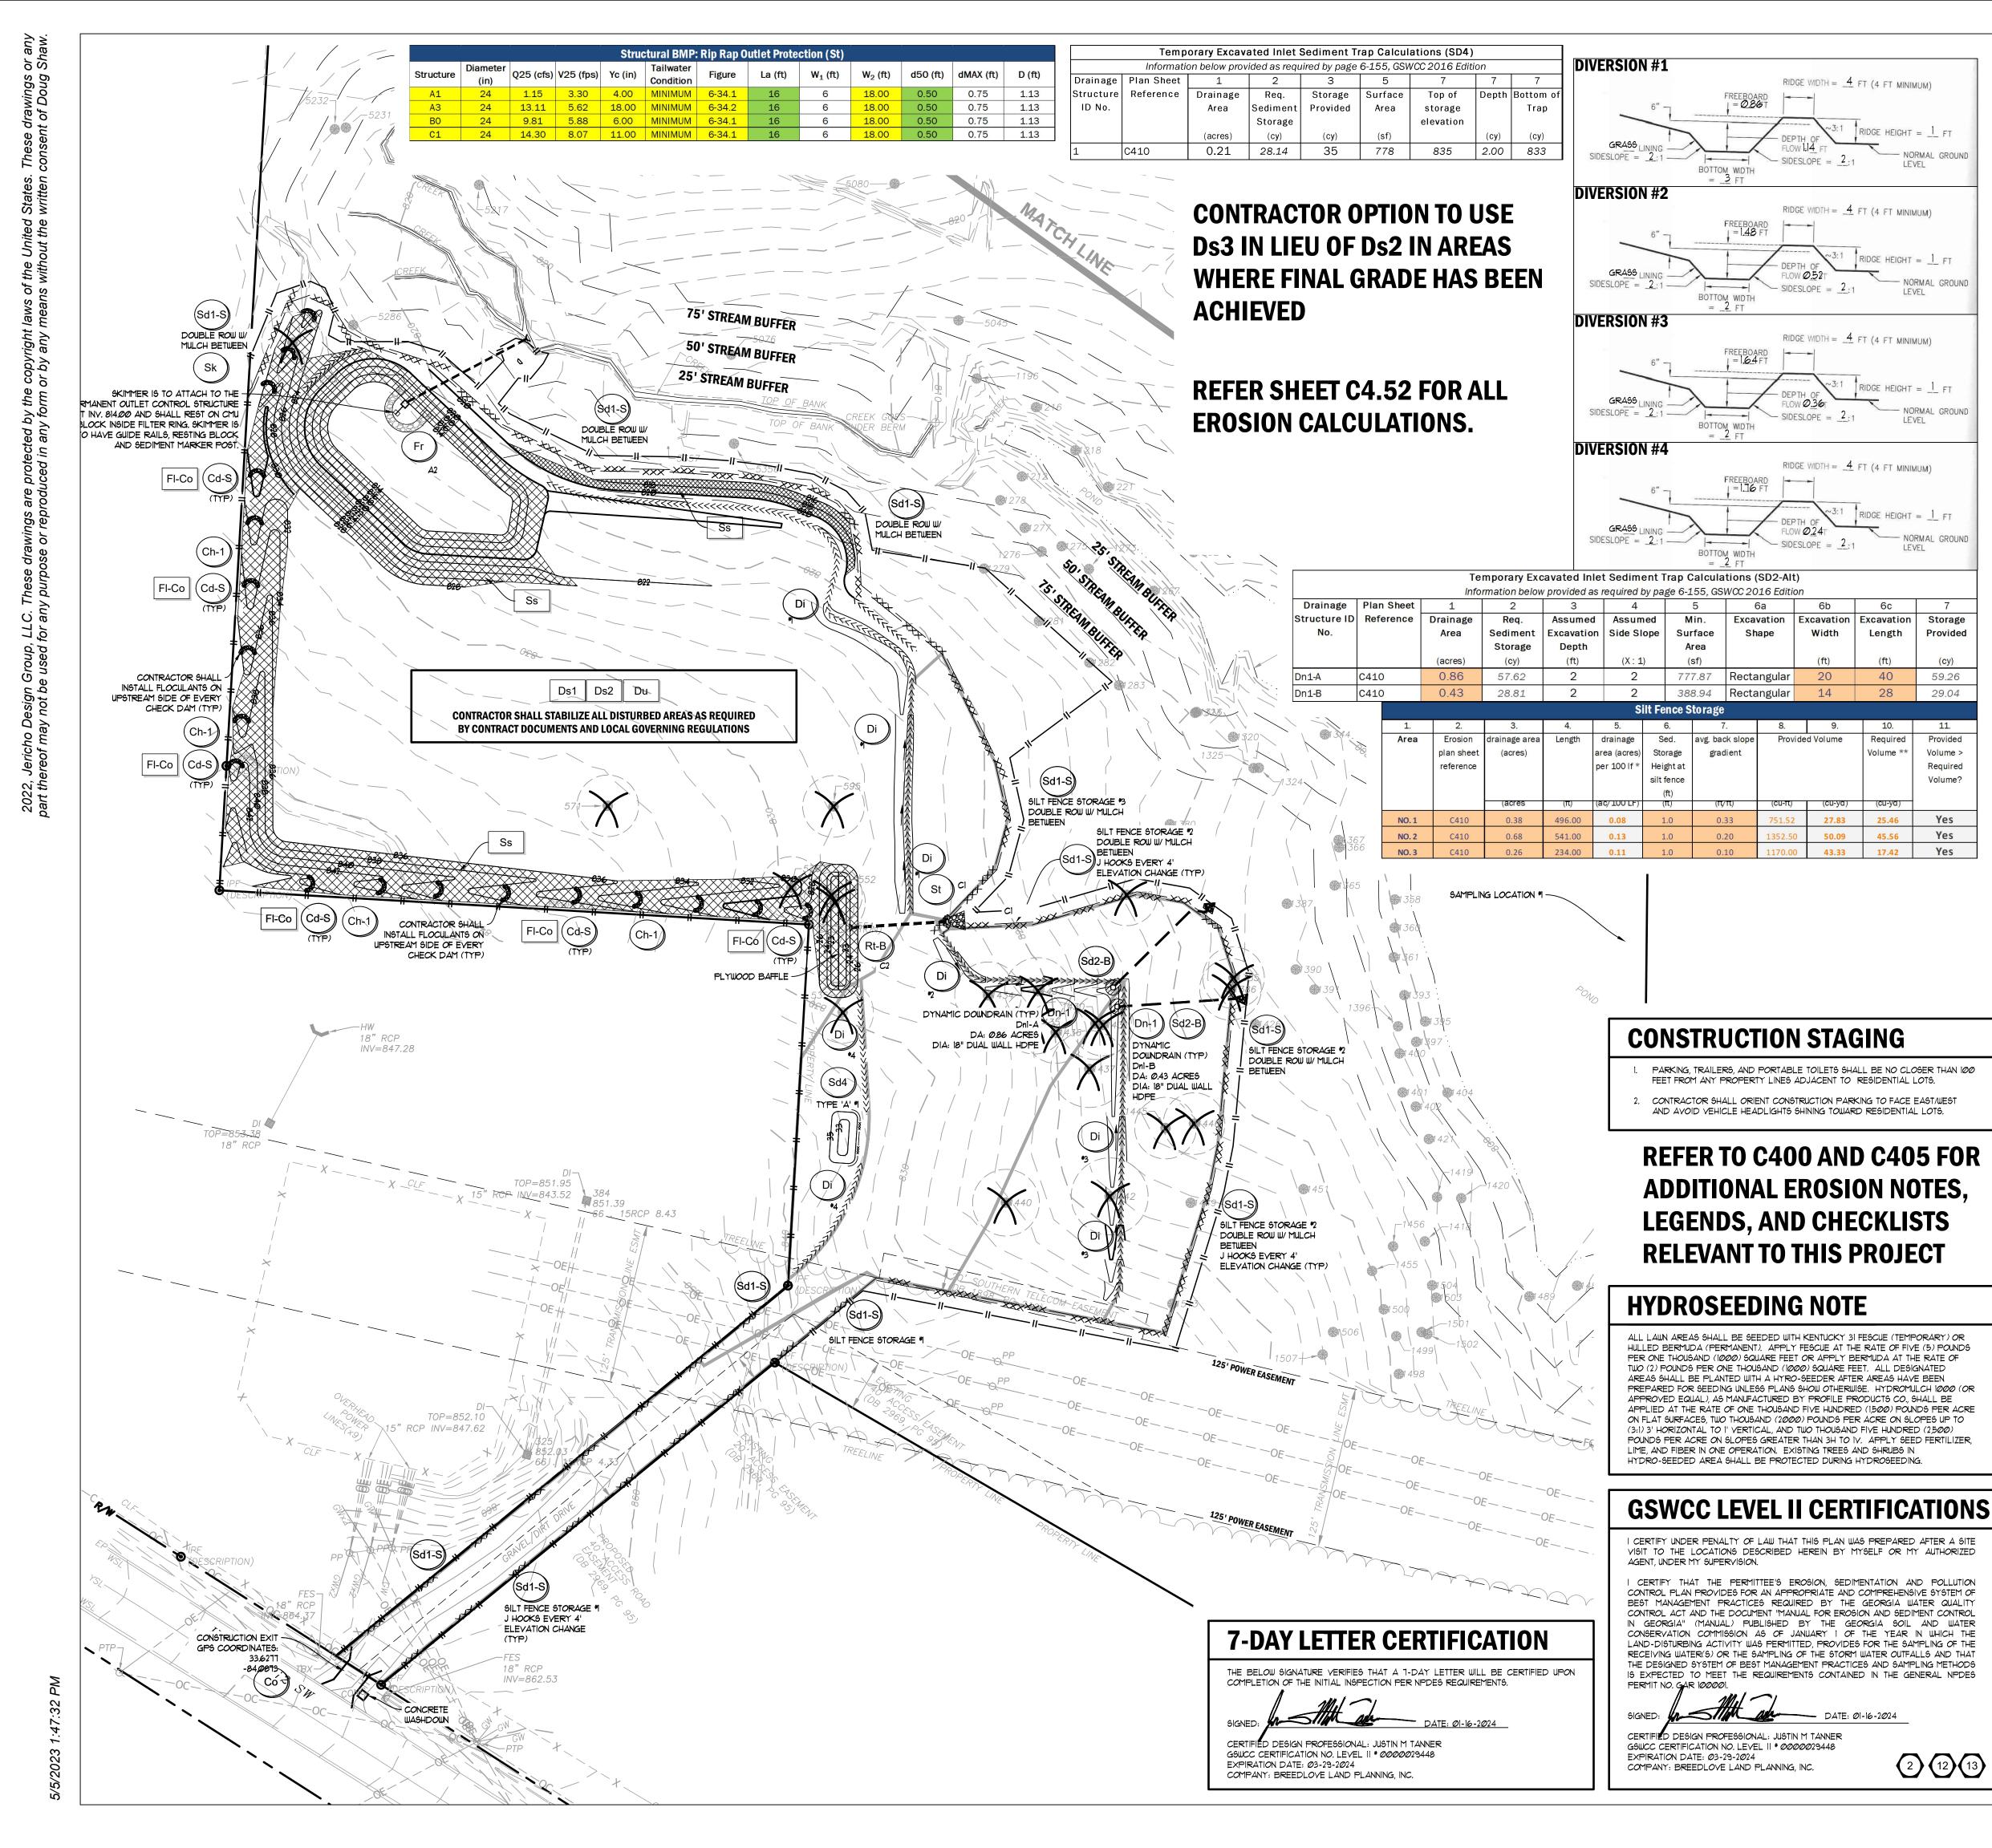

INITIAL EROSION SUMMARY

CONTRACTOR SHALL INSTALL CONSTRUCTION EXIT AND CONCRETE WASHDOWN AS SHOWN. SILT FENCE SHALL BE INSTALLED AROUND PERIMETER OF SITE. SEDIMENT TRAPS SHALL BE INSTALLED AS SHOWN ON

DISTURBED AREA

TOTAL SITE AREA: 12.45 AC

RIDGE WIDTH = $\frac{4}{10}$ FT (4 FT MINIMUM)

RIDGE WIDTH = $\frac{4}{}$ FT (4 FT MINIMUM)

RIDGE WIDTH = $\frac{4}{10}$ FT (4 FT MINIMUM)

RIDGE WIDTH = $\frac{4}{10}$ FT (4 FT MINIMUM)

Width

RIDGE HEIGHT = __ FT

Length

Volume *

Provided

59.26

Provided

Volume >

Required

Yes

Yes

2 12 13

GENERAL EROSION NOTES

NOTIFY CITY/COUNTY INSPECTORS 24 HOURS BEFORE BEGINNING OF EVERY CONSTRUCTION PHASE.

DISTURBED AREA: 8.15 AC

- ALL BUFFERS AND TREE SAVE AREAS SHALL BE CLEARLY IDENTIFIED BY FLAGGING AND/OR FENCING PRIOR TO COMMENCEMENT OF ANY LAND
- THE INSTALLATION OF EROSION AND SEDIMENTATION CONTROL MEASURES AND PRACTICES SHALL OCCUR PRIOR TO OR CONCURRENT WITH LAND DISTURBING ACTIVITIES AND CONSTRUCTION ON THE SITE AND MAINTAINED UNTIL PERMANENT GROUNDCOVER IS ESTABLISHED.
- ALL SEDIMENT BARRIERS SHALL BE INSTALLED PRIOR TO ANY GRADING.
- SEDIMENT BARRIER DEVICES SHALL BE INSPECTED AND REPAIRED OF DAMAGE DAILY. ANY ACCUMULATED SEDIMENT SHALL BE REMOVED AND SPREAD ON SITE.
- ALL DISTURBED AREAS SHALL BE GRASSED AS SOON AS CONSTRUCTION
- EROSION AND SEDIMENTATION CONTROL MEASURES SHALL BE MAINTAINED AT ALL TIMES. ADDITIONAL EROSION AND SEDIMENTATION CONTROL MEASURES SHALL BE INSTALLED IF DEEMED NECESSARY BY ON-SITE INSPECTION OR AS REQUIRED BY CITY/COUNTY AT NO ADDITIONAL COST TO THE OWNER.
- MAINTENANCE OF ALL SOIL EROSION AND SEDIMENTATION CONTROL MEASURES AND PRACTICES, WHETHER TEMPORARY OF PERMANENT, SHALL BE THE RESPONSIBILITY OF THE CONTRACTOR/OWNER.
- ANY DISCREPANCY BETWEEN THIS SHEET AND OTHERS IN THIS SET SHALL BE REFERRED TO THE ARCHITECT BY THE CONTRACTOR FOR CLARIFICATION BEFORE PROCEEDING WITH THE WORK.
- . SEDIMENT STORAGE LEVEL MARKERS MUST BE INSTALLED IN SEDIMENT STORAGE STRUCTURES, INDICATING THE 1/3 FULL VOLUME.
- MAXIMUM CUT OR FILL SLOPE IS (2:1) 2' HORIZONTAL TO I' VERTICAL.
- CONTRACTOR SHALL PROVIDE TEMPORARY DOWN DRAINS ON FILL SLOPES TO PREVENT EROSION PRIOR TO STABILIZATION. CONTRACTOR SHALL REMOVE ACCUMULATED SEDIMENT FROM DETENTION BASIN
- AT END OF CONSTRUCTION WHEN ALL DISTURBED AREAS HAVE BEEN FULLY
- 14. THE ESCAPE OF SEDIMENT FROM THE SITE SHALL BE PREVENTED BY THE INSTALLATION OF EROSION AND SEDIMENT CONTROL MEASURES AND PRACTICES PRIOR TO LAND DISTURBING ACTIVITIES.
- EROSION CONTROL MEASURES WILL BE MAINTAINED AT ALL TIMES. IF FULL IMPLEMENTATION OF THE APPROVED PLAN DOES NOT PROVIDE FOR EFFECTIVE EROSION CONTROL, ADDITIONAL EROSION AND SEDIMENT CONTROL MEASURES SHALL BE IMPLEMENTED TO CONTROL OR TREAT THE SEDIMENT SOURCE AT NO ADDITIONAL COST TO THE OWNER.
- ANY DISTURBED AREA LEFT EXPOSED FOR A PERIOD GREATER THAN 14 DAYS SHALL BE STABILIZED WITH MULCH OR TEMPORARY SEEDING.

24-HOUR EROSION CONTACT

ROCKDALE COUNTY BOC COMPANY: EMAIL ADDRESS: ANDREWHAMMER®ROCKDALECOUNTYGA.GOV

GRAPHIC SCALE & ORIENTATION

UTILITY LOCATION NOTES

- CONTRACTOR SHALL BE RESPONSIBLE TO SECURE THE SERVICES OF A PRIVATE UTILITY LOCATOR FIRM DURING THE ENTIRE COURSE OF CONSTRUCTION. CONTRACTOR SHALL PAY FOR SAID SERVICES.
- CONTRACTOR SHALL IMMEDIATELY REPAIR ALL UTILITIES DAMAGED BY CONSTRUCTION ACTIVITIES, AT NO ADDITIONAL COST TO THE OWNER.
- THE UTILITIES SHOWN ARE SCHEMATIC AND FOR THE CONTRACTOR'S CONVENIENCE ONLY. THERE MAY BE OTHER UTILITIES NOT SHOWN ON THESE PLANS. THE DESIGN PROFESSIONAL ASSUMES NO RESPONSIBILITY FOR THE LOCATIONS SHOWN AND IT SHALL BE THE CONTRACTOR'S RESPONSIBILITY TO VERIFY THE LOCATIONS OF UTILITIES WITHIN THE LIMITS OF THE WORK. DAMAGE TO EXISTING UTILITIES BY THE CONTRACTOR, FROM HIS/ HER OPERATIONS SHALL BE IMMEDIATELY REPAIRED AT NO ADDITIONAL COST TO THE OWNER.
- CONTRACTOR SHALL BE RESPONSIBLE FOR COMPACTION OF BACKFILL OF ALL UTILITY TRENCHES WITHIN SITE WORK LIMITS. THIS INCLUDES TRENCHES DUG AND BACKFILLED BY LOCAL UTILITIES, SUCH AS POWER, GAS, TELEPHONE, ETC. CONTRACTOR SHALL PROVIDE ADDITIONAL BACKFILL AND COMPACTION AS NECESSARY, IF SETTLEMENT OCCURS



NO MORE THAN 10 WORKING DAYS IN ADVANCE TO HAVE UTILITY LINES MARKED.


DO NOT BREAK OR DUPLICATE

- READ THE SPECIFICATIONS. THIS SET OF DRAWINGS AND SPECIFICATIONS DEFINE PROJECT SCOPE AND CONTRACT REQUIREMENTS. INDIVIDUAL SHEETS SEPARATED FROM THE SET MAY NOT ADEQUATELY REFLECT ALL INFORMATION NEEDED TO SUITABLY COVER CERTAIN ITEMS. DO NO SEPARATE THIS SET OF DRAWINGS INTO INDIVIDUAL SHEETS.



6

208 Pirkle Ferry Road, Suite C Cumming, GA 30040

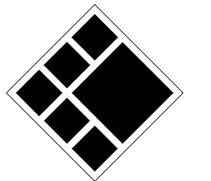


BREEDLOVE LAND PLANNING Landscape Architects ◆ Civil Engineers 15 Simpson Street, NW, Atlanta, GA 30308 P: 770-483-1173 ◆ www.landplanning.net

BLP PROJ. NO. 22158



PHONE NUMBER: 618-381-1081

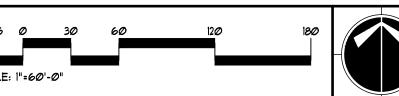

CALL BEFORE YOU DIG



GEORGIA LAW MANDATES THAT, BEFORE BEGINNING ANY MECHANIZED DIGGING OR EXCAVATION WORK, YOU MUST CONTACT GEORGIA 811 BY USING EREQUEST ON WWW.GEORGIA811.COM OR BY CALLING 811 OR 1-800-282-7411 AT LEAST 48 HOURS BUT

- DO NOT DUPLICATE DRAWINGS WITHOUT PERMISSION.

Drawn By **Checked By** Date Job No.

ROCKDALE COUN COMMISSIONERS

DESCRIPTION

LDP SUBMITTAL

LDP RESUBMITTAL

LDP RESUBMITTAL

LDP RESUBMITTAL

Sheet Title ES&PC PLAN - INITIAL

PRINT RECORD

No. DATE

1 07/31/2023


2 09/07/2023

3 10/12/2023

4 01/16/2024

PHASE

Sheet No.

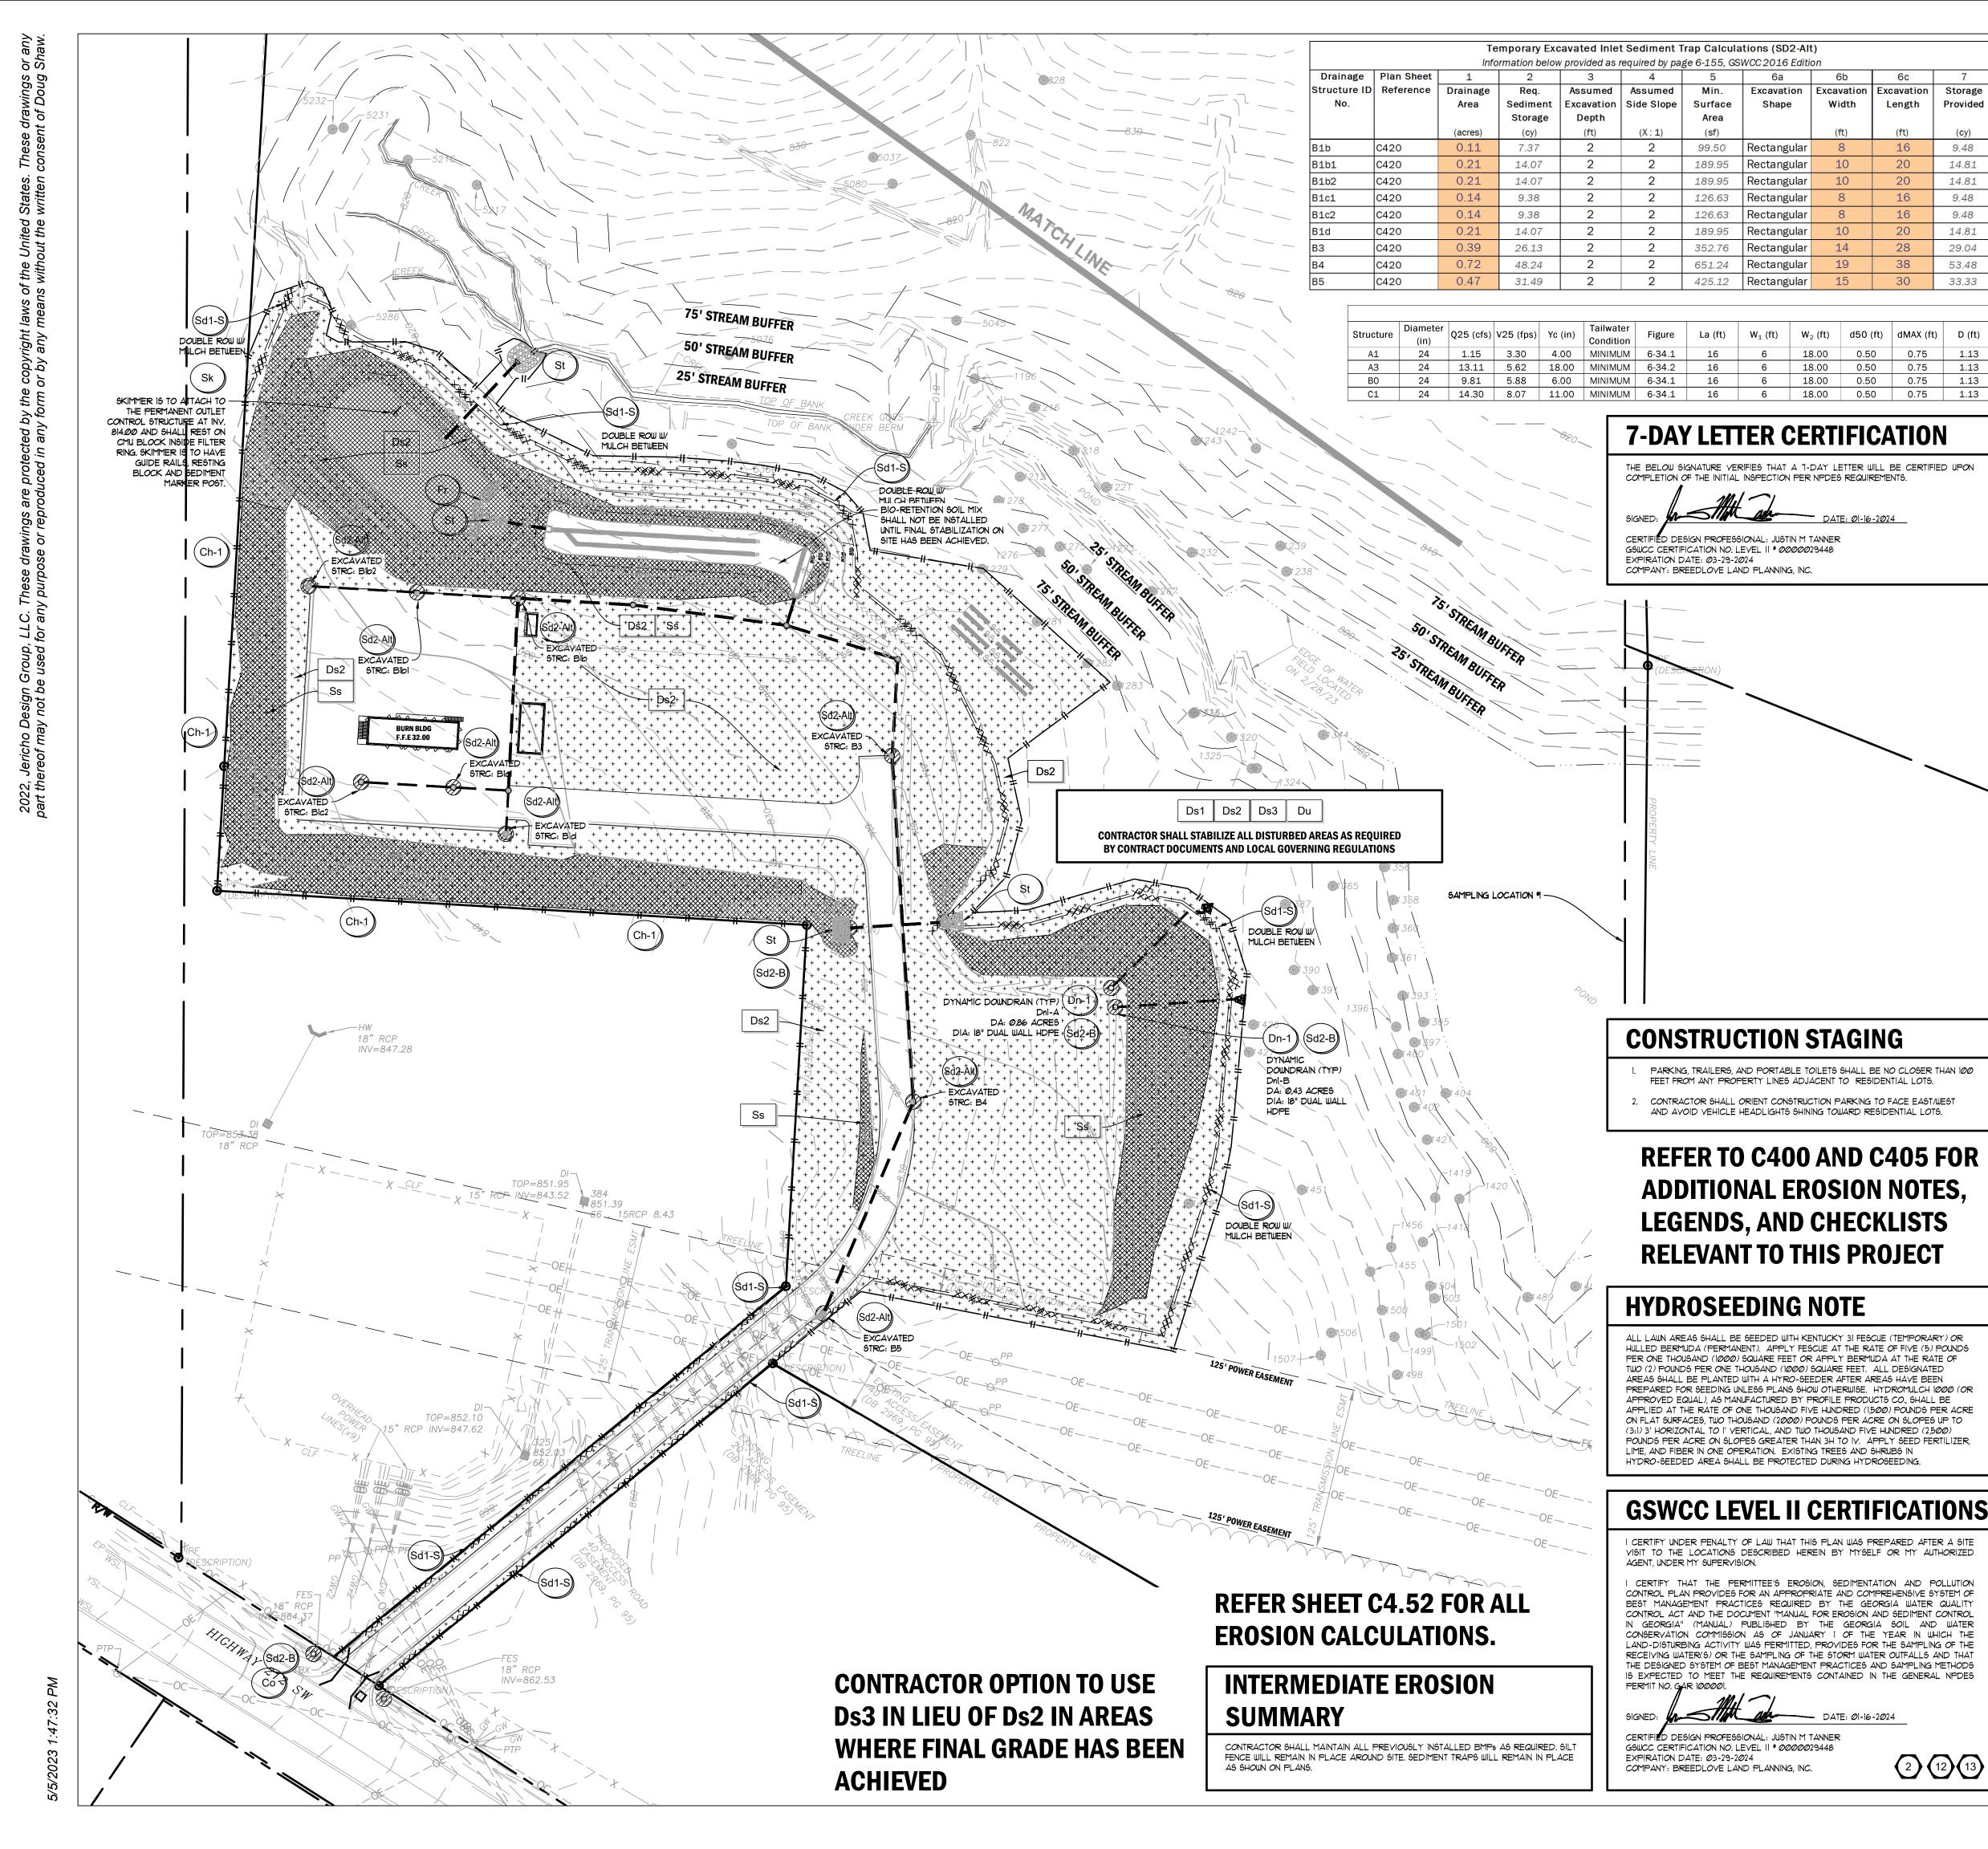

DISTURBED AREA

6a

Excavation

Rectangular

Rectangular

Rectangular

Rectangular

Rectangular

Rectangular

Excavation Excavation Storage

Length

9.48

14.81

14.81

9.48

9.48

14.81

29.04

53.48

33.33

Width

TOTAL SITE AREA: 12.45 AC DISTURBED AREA: 8.15 AC

GROUNDCOVER IS ESTABLISHED.

GENERAL EROSION NOTES

NOTIFY CITY/COUNTY INSPECTORS 24 HOURS BEFORE BEGINNING OF EVERY CONSTRUCTION PHASE.

- ALL BUFFERS AND TREE SAVE AREAS SHALL BE CLEARLY IDENTIFIED BY FLAGGING AND/OR FENCING PRIOR TO COMMENCEMENT OF ANY LAND
- THE INSTALLATION OF EROSION AND SEDIMENTATION CONTROL MEASURES AND PRACTICES SHALL OCCUR PRIOR TO OR CONCURRENT WITH LAND DISTURBING ACTIVITIES AND CONSTRUCTION ON THE SITE AND MAINTAINED UNTIL PERMANENT
- ALL SEDIMENT BARRIERS SHALL BE INSTALLED PRIOR TO ANY GRADING. SEDIMENT BARRIER DEVICES SHALL BE INSPECTED AND REPAIRED OF DAMAGE DAILY. ANY ACCUMULATED SEDIMENT SHALL BE REMOVED AND
- SPREAD ON SITE. ALL DISTURBED AREAS SHALL BE GRASSED AS SOON AS CONSTRUCTION
- EROSION AND SEDIMENTATION CONTROL MEASURES SHALL BE MAINTAINED AT ALL TIMES. ADDITIONAL EROSION AND SEDIMENTATION CONTROL MEASURES SHALL BE INSTALLED IF DEEMED NECESSARY BY ON-SITE INSPECTION OR AS REQUIRED BY CITY/COUNTY AT NO ADDITIONAL COST TO THE OWNER.
- MAINTENANCE OF ALL SOIL EROSION AND SEDIMENTATION CONTROL MEASURES AND PRACTICES, WHETHER TEMPORARY OF PERMANENT, SHALL BE THE RESPONSIBILITY OF THE CONTRACTOR/OWNER.
- ANY DISCREPANCY BETWEEN THIS SHEET AND OTHERS IN THIS SET SHALL BE REFERRED TO THE ARCHITECT BY THE CONTRACTOR FOR CLARIFICATION BEFORE PROCEEDING WITH THE WORK.
- 10. SEDIMENT STORAGE LEVEL MARKERS MUST BE INSTALLED IN SEDIMENT STORAGE STRUCTURES, INDICATING THE 1/3 FULL VOLUME.

PREVENT EROSION PRIOR TO STABILIZATION.

- MAXIMUM CUT OR FILL SLOPE IS (2:1) 2' HORIZONTAL TO 1' VERTICAL. CONTRACTOR SHALL PROVIDE TEMPORARY DOWN DRAINS ON FILL SLOPES TO
- CONTRACTOR SHALL REMOVE ACCUMULATED SEDIMENT FROM DETENTION BASIN AT END OF CONSTRUCTION WHEN ALL DISTURBED AREAS HAVE BEEN FULLY
- THE ESCAPE OF SEDIMENT FROM THE SITE SHALL BE PREVENTED BY THE INSTALLATION OF EROSION AND SEDIMENT CONTROL MEASURES AND PRACTICES PRIOR TO LAND DISTURBING ACTIVITIES.
- EROSION CONTROL MEASURES WILL BE MAINTAINED AT ALL TIMES. IF FULL IMPLEMENTATION OF THE APPROVED PLAN DOES NOT PROVIDE FOR EFFECTIVE EROSION CONTROL, ADDITIONAL EROSION AND SEDIMENT CONTROL MEASURES SHALL BE IMPLEMENTED TO CONTROL OR TREAT THE SEDIMENT SOURCE AT NO ADDITIONAL COST TO THE OWNER.
- 16. ANY DISTURBED AREA LEFT EXPOSED FOR A PERIOD GREATER THAN 14 DAYS SHALL BE STABILIZED WITH MULCH OR TEMPORARY SEEDING.

24-HOUR EROSION CONTACT

ROCKDALE COUNTY BOC COMPANY:

GRAPHIC SCALE & ORIENTATION


- CONTRACTOR SHALL BE RESPONSIBLE TO SECURE THE SERVICES OF A PRIVATE UTILITY LOCATOR FIRM DURING THE ENTIRE COURSE OF CONSTRUCTION.
- CONTRACTOR SHALL IMMEDIATELY REPAIR ALL UTILITIES DAMAGED BY
- THE UTILITIES SHOWN ARE SCHEMATIC AND FOR THE CONTRACTOR'S CONVENIENCE ONLY. THERE MAY BE OTHER UTILITIES NOT SHOWN ON THESE PLANS. THE DESIGN PROFESSIONAL ASSUMES NO RESPONSIBILITY FOR THE LOCATIONS SHOWN AND IT SHALL BE THE CONTRACTOR'S RESPONSIBILITY TO VERIFY THE LOCATIONS OF UTILITIES WITHIN THE LIMITS OF THE WORK. DAMAGE TO EXISTING UTILITIES BY THE CONTRACTOR, FROM HIS/ HER OPERATIONS
- CONTRACTOR SHALL BE RESPONSIBLE FOR COMPACTION OF BACKFILL OF ALL UTILITY TRENCHES WITHIN SITE WORK LIMITS. THIS INCLUDES TRENCHES DUG AND BACKFILLED BY LOCAL UTILITIES, SUCH AS POWER, GAS, TELEPHONE, ETC. CONTRACTOR SHALL PROVIDE ADDITIONAL BACKFILL AND COMPACTION AS NECESSARY, IF SETTLEMENT OCCURS

2 12 13




NO MORE THAN 10 WORKING DAYS IN ADVANCE TO HAVE UTILITY LINES MARKED.

- DO NOT DUPLICATE DRAWINGS WITHOUT PERMISSION.
- READ THE SPECIFICATIONS. THIS SET OF DRAWINGS AND SPECIFICATIONS DEFINE PROJECT SCOPE AND CONTRACT REQUIREMENTS. INDIVIDUAL SHEETS SEPARATED FROM THE SET MAY NOT ADEQUATELY REFLECT ALL INFORMATION NEEDED TO SUITABLY COVER CERTAIN ITEMS. DO NO SEPARATE THIS SET OF DRAWINGS INTO INDIVIDUAL SHEETS.

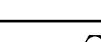



208 Pirkle Ferry Road, Suite C Cumming, GA 30040

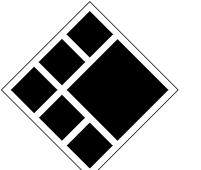

BREEDLOVE LAND PLANNING Landscape Architects ◆ Civil Engineers 15 Simpson Street, NW, Atlanta, GA 30308 P: 770-483-1173 ◆ www.landplanning.net

BLP PROJ. NO. 22158



EMAIL ADDRESS: ANDREWHAMMER®ROCKDALECOUNTYGA.GOV

UTILITY LOCATION NOTES

- CONTRACTOR SHALL PAY FOR SAID SERVICES.
- CONSTRUCTION ACTIVITIES, AT NO ADDITIONAL COST TO THE OWNER.
- SHALL BE IMMEDIATELY REPAIRED AT NO ADDITIONAL COST TO THE OWNER

CALL BEFORE YOU DIG



EXCAVATION WORK, YOU MUST CONTACT GEORGIA 811 BY USING EREQUEST ON WWW.GEORGIA811.COM OR BY CALLING 811 OR 1-800-282-7411 AT LEAST 48 HOURS BUT

DO NOT BREAK OR DUPLICATE

Drawn By Checked By Date Job No.

ROCKDALE COUN COMMISSIONERS

DESCRIPTION

LDP SUBMITTAL

LDP RESUBMITTAL

LDP RESUBMITTAL

LDP RESUBMITTAL

Sheet Title

PRINT RECORD

No. DATE

1 07/31/2023


2 09/07/2023

3 10/12/2023

4 01/16/2024

ES&PC PLAN -**INTERMEDIATE PHASE**

Sheet No.

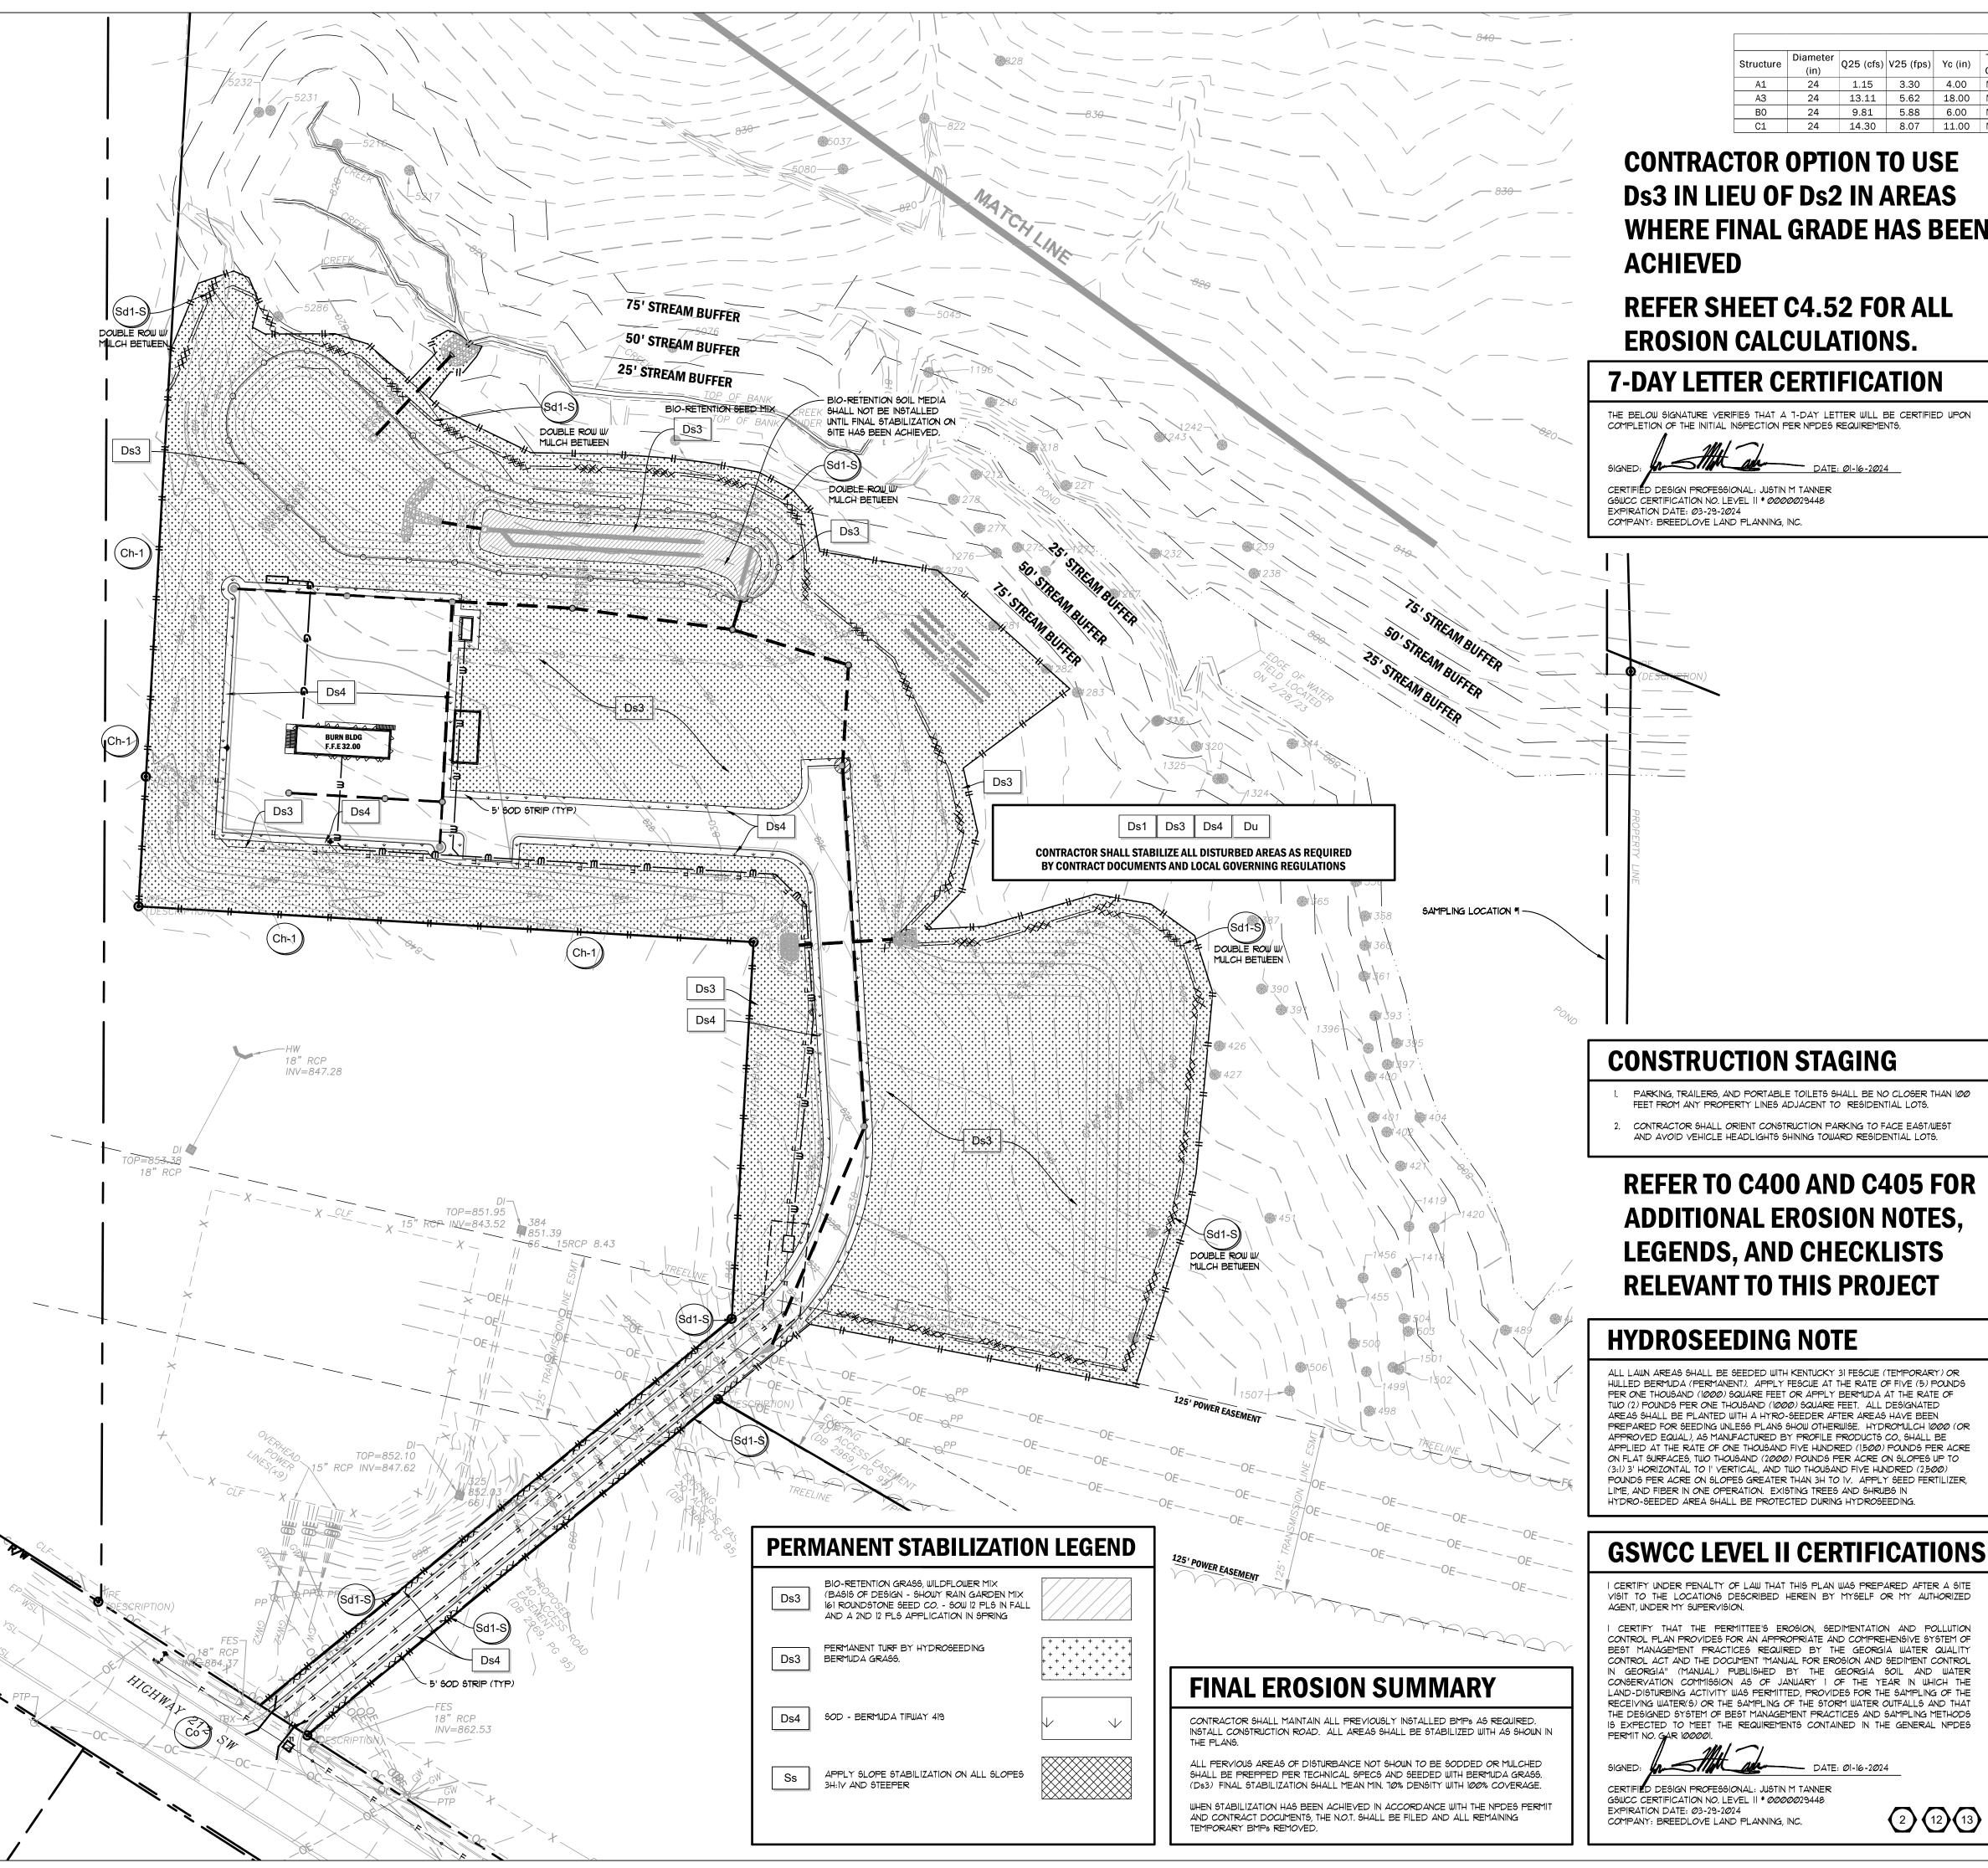

9.81 | 5.88 | 6.00 | MINIMUM | 6-34.1 | 16

CONTRACTOR OPTION TO USE Ds3 IN LIEU OF Ds2 IN AREAS WHERE FINAL GRADE HAS BEEN **ACHIEVED**

REFER SHEET C4.52 FOR ALL EROSION CALCULATIONS.

7-DAY LETTER CERTIFICATION

THE BELOW SIGNATURE VERIFIES THAT A 1-DAY LETTER WILL BE CERTIFIED UPON COMPLETION OF THE INITIAL INSPECTION PER NPDES REQUIREMENTS.

CERTIFIED DESIGN PROFESSIONAL: JUSTIN M TANNER GSWCC CERTIFICATION NO. LEVEL II * 0000029448

COMPANY: BREEDLOVE LAND PLANNING, INC.

DISTURBED AREA

DISTURBED AREA: 8.15 AC

GENERAL EROSION NOTES

NOTIFY CITY/COUNTY INSPECTORS 24 HOURS BEFORE BEGINNING OF EVERY CONSTRUCTION PHASE.


- ALL BUFFERS AND TREE SAVE AREAS SHALL BE CLEARLY IDENTIFIED BY FLAGGING AND/OR FENCING PRIOR TO COMMENCEMENT OF ANY LAND
- THE INSTALLATION OF EROSION AND SEDIMENTATION CONTROL MEASURES AND PRACTICES SHALL OCCUR PRIOR TO OR CONCURRENT WITH LAND DISTURBING ACTIVITIES AND CONSTRUCTION ON THE SITE AND MAINTAINED UNTIL PERMANENT GROUNDCOVER IS ESTABLISHED.
- ALL SEDIMENT BARRIERS SHALL BE INSTALLED PRIOR TO ANY GRADING
- SEDIMENT BARRIER DEVICES SHALL BE INSPECTED AND REPAIRED OF DAMAGE DAILY. ANY ACCUMULATED SEDIMENT SHALL BE REMOVED AND
- ALL DISTURBED AREAS SHALL BE GRASSED AS SOON AS CONSTRUCTION
- EROSION AND SEDIMENTATION CONTROL MEASURES SHALL BE MAINTAINED AT ALL TIMES. ADDITIONAL EROSION AND SEDIMENTATION CONTROL MEASURES SHALL BE INSTALLED IF DEEMED NECESSARY BY ON-SITE INSPECTION OR AS REQUIRED BY CITY/COUNTY AT NO ADDITIONAL COST TO THE OWNER.
- MAINTENANCE OF ALL SOIL EROSION AND SEDIMENTATION CONTROL MEASURES AND PRACTICES, WHETHER TEMPORARY OF PERMANENT, SHALL BE THE RESPONSIBILITY OF THE CONTRACTOR/OWNER.
- ANY DISCREPANCY BETWEEN THIS SHEET AND OTHERS IN THIS SET SHALL BE REFERRED TO THE ARCHITECT BY THE CONTRACTOR FOR CLARIFICATION BEFORE PROCEEDING WITH THE WORK.
- 10. SEDIMENT STORAGE LEVEL MARKERS MUST BE INSTALLED IN SEDIMENT STORAGE STRUCTURES, INDICATING THE 1/3 FULL VOLUME.
- MAXIMUM CUT OR FILL SLOPE 15 (2:1) 2' HORIZONTAL TO 1' VERTICAL.
- CONTRACTOR SHALL PROVIDE TEMPORARY DOWN DRAINS ON FILL SLOPES TO PREVENT EROSION PRIOR TO STABILIZATION. 13. CONTRACTOR SHALL REMOVE ACCUMULATED SEDIMENT FROM DETENTION BASIN
- AT END OF CONSTRUCTION WHEN ALL DISTURBED AREAS HAVE BEEN FULLY
- 14. THE ESCAPE OF SEDIMENT FROM THE SITE SHALL BE PREVENTED BY THE INSTALLATION OF EROSION AND SEDIMENT CONTROL MEASURES AND PRACTICES PRIOR TO LAND DISTURBING ACTIVITIES.
- EROSION CONTROL MEASURES WILL BE MAINTAINED AT ALL TIMES. IF FULL IMPLEMENTATION OF THE APPROVED PLAN DOES NOT PROVIDE FOR EFFECTIVE EROSION CONTROL, ADDITIONAL EROSION AND SEDIMENT CONTROL MEASURES SHALL BE IMPLEMENTED TO CONTROL OR TREAT THE SEDIMENT SOURCE AT NO ADDITIONAL COST TO THE OWNER.
- ANY DISTURBED AREA LEFT EXPOSED FOR A PERIOD GREATER THAN 14 DAYS SHALL BE STABILIZED WITH MULCH OR TEMPORARY SEEDING.

24-HOUR EROSION CONTACT

ROCKDALE COUNTY BOC COMPANY:

EMAIL ADDRESS: ANDREWHAMMER®ROCKDALECOUNTYGAGOV PHONE NUMBER: 618-381-1081

GRAPHIC SCALE & ORIENTATION

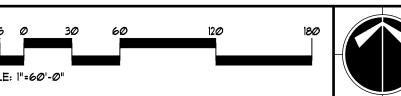

UTILITY LOCATION NOTES

- CONTRACTOR SHALL BE RESPONSIBLE TO SECURE THE SERVICES OF A PRIVATE UTILITY LOCATOR FIRM DURING THE ENTIRE COURSE OF CONSTRUCTION. CONTRACTOR SHALL PAY FOR SAID SERVICES.
- CONTRACTOR SHALL IMMEDIATELY REPAIR ALL UTILITIES DAMAGED BY CONSTRUCTION ACTIVITIES, AT NO ADDITIONAL COST TO THE OWNER.
- THE UTILITIES SHOWN ARE SCHEMATIC AND FOR THE CONTRACTOR'S CONVENIENCE ONLY. THERE MAY BE OTHER UTILITIES NOT SHOWN ON THESE PLANS. THE DESIGN PROFESSIONAL ASSUMES NO RESPONSIBILITY FOR THE LOCATIONS SHOWN AND IT SHALL BE THE CONTRACTOR'S RESPONSIBILITY TO VERIFY THE LOCATIONS OF UTILITIES WITHIN THE LIMITS OF THE WORK. DAMAGE TO EXISTING UTILITIES BY THE CONTRACTOR, FROM HIS/ HER OPERATIONS SHALL BE IMMEDIATELY REPAIRED AT NO ADDITIONAL COST TO THE OWNER.
- CONTRACTOR SHALL BE RESPONSIBLE FOR COMPACTION OF BACKFILL OF ALL UTILITY TRENCHES WITHIN SITE WORK LIMITS. THIS INCLUDES TRENCHES DUG AND BACKFILLED BY LOCAL UTILITIES, SUCH AS POWER, GAS, TELEPHONE, ETC. CONTRACTOR SHALL PROVIDE ADDITIONAL BACKFILL AND COMPACTION AS NECESSARY, IF SETTLEMENT OCCURS

CALL BEFORE YOU DIG

2 12 13




GEORGIA LAW MANDATES THAT, BEFORE BEGINNING ANY MECHANIZED DIGGING OR EXCAVATION WORK, YOU MUST CONTACT GEORGIA 811 BY USING EREQUEST ON WWW.GEORGIA811.COM OR BY CALLING 811 OR 1-800-282-7411 AT LEAST 48 HOURS BUT NO MORE THAN 10 WORKING DAYS IN ADVANCE TO HAVE UTILITY LINES MARKED.

DO NOT BREAK OR DUPLICATE

- DO NOT DUPLICATE DRAWINGS WITHOUT PERMISSION.
- READ THE SPECIFICATIONS. THIS SET OF DRAWINGS AND SPECIFICATIONS DEFINE PROJECT SCOPE AND CONTRACT REQUIREMENTS. INDIVIDUAL SHEETS SEPARATED FROM THE SET MAY NOT ADEQUATELY REFLECT ALL INFORMATION NEEDED TO SUITABLY COVER CERTAIN ITEMS. DO NO SEPARATE THIS SET OF DRAWINGS INTO INDIVIDUAL SHEETS.



208 Pirkle Ferry Road, Suite C Cumming, GA 30040

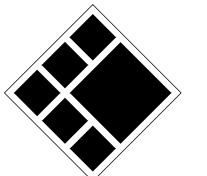

BREEDLOVE LAND PLANNING Landscape Architects ◆ Civil Engineers 15 Simpson Street, NW, Atlanta, GA 30308 P: 770-483-1173 ◆ www.landplanning.net

BLP PROJ. NO. 22158



ROCKDALE COUN COMMISSIONERS

DDINT DECODO

PRINT RECORD		
DATE	DESCRIPTION	
07/31/2023	LDP SUBMITTAL	
09/07/2023	LDP RESUBMITTAL	
10/12/2023	LDP RESUBMITTAL	
01/16/2024	LDP RESUBMITTAL	
	DATE 07/31/2023 09/07/2023 10/12/2023	

Drawn By **Checked By** Date Job No.

05/05/2023

Sheet Title

ES&PC PLAN -FINAL PHASE

Sheet No.

SILT SAVER

USE STEEL POSTS THAT MEET STATE STANDARDS &

SPECIFICATIONS FOR THE STATE THAT THE SILT

USE WOVEN-IN BELTS AS ATTACHMENT POINTS

FENCE WILL BE INSTALLED.

FOR THE TIES.

4' WOOD (OAK/HARDWOOD)

POST SPACED AT 4'-0"

FRONT ELEVATION

WOVEN BELTED SILT FENCE (WBSF)

2 STAGE COMBO (2CB)

WBSF2CB-4

SILT-SAVER, INC. 1200 FORRESTER CEMETERY RD, COVINGTON, GA. 30014 PHONE: (770) 388-7818 www.siltsaver.co

FABRIC TO BE 24" ABOVE GROUND WITH "J" IN TRENCH

TOE IN AND COMPACT BACKFILL

OF SLOPE

SIDE VIEW

36" SILT-SAVER WBSFCB

MINIMUM OF 8" BLACK UV 120 LBS

I" X 1 1/4" STAPLES FOR WOOD TO BE PLACED AT EACH SUPPORT BELT.

- GROUND LINE

— воттом о**г**

USE OAK/HARDWOOD POST

1 3/4 x 1 1/4 x 48" OR EQUAL

WHICH EVER IS GREATER.

REPAIR DETAIL

WHEN TRENCHING IS USED

ECTION OF RUNOFF WATER BARRIC MATERIAL

PLAN VIEW

SCALE: NOT TO SCALE

LAST UPDATED: MARCH 2022

FRAME MATERIAL: OAK/HARDWOOD OR STEEL

FILTER FABRIC MATERIAL: REFER TO SPEC

ATTACHING TWO SILT FENCES

DENSITY OR STATE STANDARDS,


ENCE INSIDE THE END POST OF THE OTHER

ABOUT 12 INCHES INT.
THE GROUND AND
BURY THE FLAP IN A
TRENCH

ZIP TIES FOR STEEL

. CONTRACTOR SHALL CONTINUOUSLY MONITOR AND MAINTAIN DOWNDRAIN STRUCTURES AND DIVERSION BERM(S)/DITCHES. 2. CONTRACTOR SHALL KEEP DOWNDRAIN STRUCTURES CLEAR OF TRASH AND DEBRIS AND THEN REMOVE ACCUMULATED SEDIMENT FROM AROUND THE GRAVEL FILTER CONE WHEN 1/3 FULL. 3UPON FINAL STABILIZATION, DOWNDRAINS SHALL BE REMOVED AND ALL DISTURBED AREAS STABILIZED WITH DIS AND/OR DISA. 4. PLACE DOWNDRAINS ON UNDISTURBED SOIL OR WELL-COMPACTED FILL PER PLANS. 5. HAND TAMP THE SOIL UNDER AND AROUND THE ENTRANCE SECTION IN LIFTS NOT TO EXCEED 6" 6. ALL PIPE CONNECTIONS SHALL BE WATERTIGHT. 18" MIN. TALL DIVERSION BERM PROVIDE BAFLLE BOX AT DOWNLINE INLET OPENING. SIDE SLOPES 3:1 MAX OPENING FOR DOGHOUSE SHALL NON-PERFORATED HDPE PIPE W/ MATCH DOWNLINE SIZE. SPLIT COUPLINGS WITH ZIP NYLON TIES TO HOLD COUPLINGS AND PIPE REFER TO Rt-B DETAIL. TOGETHER - SIZED AS PER PLAN(S) STABILIZED OUTLET PROTECTION
PROVIDE 9"Lx 6"W 90 LB. RIP-RAP #51 GRAVEL FILTER CONE AREA FOR OUTLET PROTECTION (TYP. EACH DOWNLINE) PAM LOG OR GEL BAR TIE-DOWN STAKES MINVERT OF HOPE 98% COMPACTED SUBGRADE BY STANDARD PROCTOR TEMPORARY DOWNDRAIN STRUCTURE NOT TO SCALE CONTRACTOR SHALL INSPECT TRAP DAILY AND MAKE NECESSARY REPAIRS 4"x4" POST (TYP. IMMEDIATELY. CONTRACTOR SHALL CLEAN OUT ACCUMULATED SEDIMENT WHEN \$ OF THE BASIN IS FULL AND/OR AFTER EACH MAJOR RAIN EVENT. CONTRACTOR SHALL REMOVE 3"-4" STONE, EXTEND TO TOP OF 2x4's TRAP ONCE DISTURBED AREAS ARE 2"x4" BOARDS W/ 1/2" - 1" SPACING REFER TO PLANS AND CALCULATIONS SHEET FOR SEDIMENT STORAGE PROVISIONS FOR EACH SPECIFIC APPLICATION OF THIS BEST MANAGEMENT PRACTICE (BMP) NOT TO SCALE

SEDIMENT SHALL BE REMOVED WHEN IT REACHES A DEPTH OF $\frac{1}{2}$ THE ORIGINAL DAM HEIGHT. IF AREA IS TO BE MOWED, CHECK DAMS SHALL BE REMOVED ONCE FINAL STABILIZATION HAS OCCURRED. AFTER REMOVAL, AREA BENEATH CHECK DAMS SHALL BE SEEDED AND MULCHED IMMEDIATELY. TRIPLE-LAYER OF JUTE FABRIC MATTING IMPREGNATED WITH ANIONIC E OF SWALE OR DITCH POLYACRYLAMIDE (PAM) DRAPED OVER ENTIRE TOP OF GRAVEL, PER TECHNICAL SPECIFICATIONS TRÊNCH & BURY EDGE OF JUTE FABRIC 6" DEEP ALONG ENTIRE EXISTING GRADE MĀX 2-10" STONE FACE OF CHECK DAM, INSTALLED SAME DAY AS STONE. TEMPORARY AND PERMANENT STONE CHECK DAM

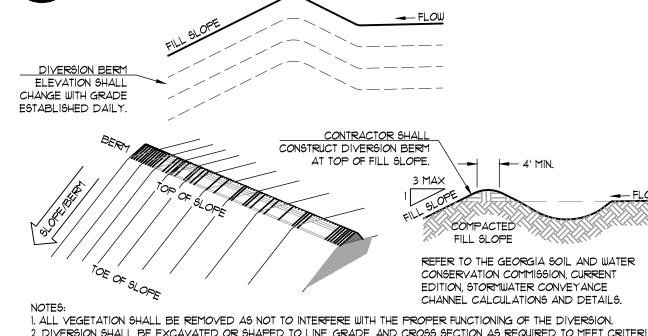


2. DIVERSION SHALL BE EXCAVATED OR SHAPED TO LINE, GRADE, AND CROSS SECTION AS REQUIRED TO MEET CRITERIA OF THE GEORGIA SOIL AND WATER CONSERVATION COMMISSION, CURRENT EDITION. 3. ALL FILL SHALL BE MACHINE COMPACTED AS NEEDED TO PREVENT UNEQUAL SETTLEMENT THAT WOULD CAUSE DAMAGE TO THE 4. ALL EARTH REMOVED SHALL BE SPREAD OR DISPOSED OF SO THAT IT DOES NOT INTERFERE WITH THE FUNCTIONING OF THE 5. DIVERSION SHALL BE STABILIZED PER CHANNEL STABILIZATION DETAIL (Ch).


DI) TEMPORARY DIVERSION NOT TO SCALE

I. EACH BALE SHALL BE EMBEDDED IN THE SOIL A MINIMUM OF (4) INCHES AND PLACED SO THE BINDINGS ARE HORIZONTAL. 2. BALES SHALL BE SECURELY ANCHORED IN PLACE. 3. CONTRACTOR SHALL PROVIDE SEDIMENT DEPTH MARKER IN TRAP. REFER TO DETAIL. 4. MAXIMUM LIFE OF SEDIMENT TRAP IS 6 MONTHS.

TRAP SHALL BE INSPECTED REGULARLY AND AFTER LARGE RAIN EVENTS. SEDIMENT SHALL BE REMOVED WHEN TRAP IS \$ FULL BALES SHALL BE INSPECTED FREQUENTLY AND REPAIRED AND/OR REPLACED PROMPTLY AS NEEDED. BALES SHALL BE REMOVED WHEN SURROUNDING AREAS HAVE BEEN STABILIZED SO AS NOT TO BLOCK OR IMPEDE STORM FLOW OR DRAINAGE.

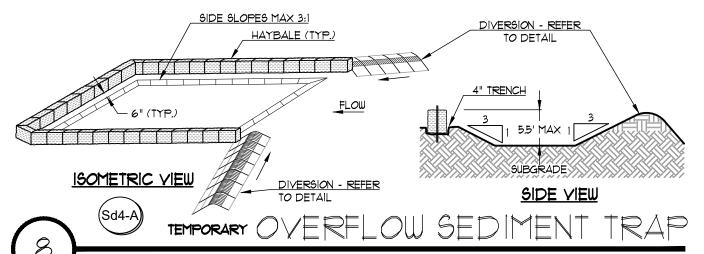

MAINTENANCE:
INSPECT BLANKETS AND MATTING PERIODICALLY FOLLOWING INSTALLATION, ESPECIALLY AFTER RAIN EVENTS. ANY DISLOCATION OR FAILURE SHALL BE REPAIRED IMMEDIATELY. IF WASHOUT OR BREAKAGE OCCURS, MATERIAL SHALL BE UNINSTALLED, 6LOPE REPAIRED, THEN MATERIAL REINSTALLED. BMP SHALL BE MONITORED UNTIL AREA HAS BEEN

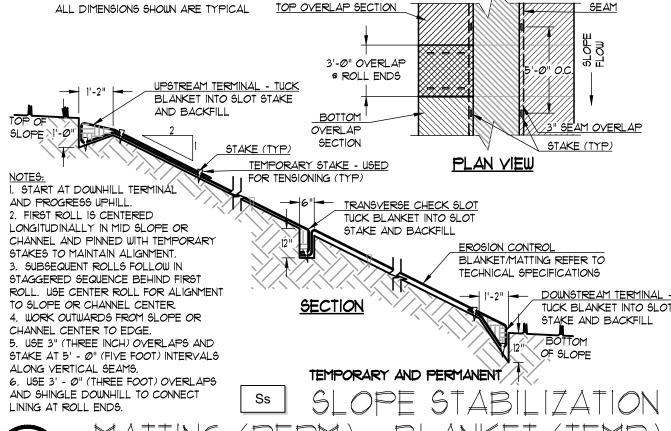

CONCRETE TRUCK **WASHOUT AREA** Illegal discharges are subject to fines and

penalties.

NOT TO SCALE

CONTRACTOR SHALL PROVIDE WATER PROOF TEMPORARY CONCRETE WASHOUT AREA SIGN. SIGN SHALL BE INSTALLED NEAR CONSTRUCTION ENTRANCE/EXIT, REMOTE FROM WATERWAYS, AND AS IDENTIFIED ON ES&PC PLANS. PROVIDE 2 GALVANIZED "U" CHANNEL POSTS WITH 6 - 3/8 P" NYLON LOCK NUT, FLAT WASHERS AND BOLT CONNECTIONS. DO NOT NAIL SIGN TO TREE. COLOR SHALL BE WHITE BACKGROUND WITH KELLY GREEN LETTERING. PROVIDE SUBMITTAL FOR DESIGN PROFESSIONAL APPROVAL PRIOR TO INSTALLATION, UPON COMPLETION OF CONSTRUCTION PROJECT, REMOVE SIGN


AND POST FROM SITE. CONCRETE TRUCK WASHOUT AREA SIGN - TEMPORARY

NOT TO SCALE

I. CONTRACTORS OPTION TO GRADE OUT CONTAINMENT AREA WITH DIVERSION BERMS OR CONSTRUCT WITH HAY BALES, BALES SHALL BE PLACED AT THE TOE OF A SLOPE OR ON THE CONTOUR AND IN A ROW WITH ENDS TIGHTLY ABUTTING THE ADJACENT 2. EACH BALE SHALL BE EMBEDDED IN THE SOIL A MINIMUM OF (4) INCHES, AND PLACED SO THE BINDINGS ARE HORIZONTAL. 3. BALES SHALL BE SECURELY ANCHORED IN PLACE BY EITHER TWO STAKES OR REBAR DRIVEN THROUGH THE BALE. THE FIRST STAKE IN EACH BALE SHALL BE DRIVEN TOWARDS THE PREVIOUSLY LAID BALE AT AN ANGLE TO FORCE THE BALES TOGETHER. STAKES SHALL BE DRIVEN FLUSH WITH THE BALE. 4. CONTRACTOR SHALL PROVIDE AND INSTALL 36" X 36" SIGN IDENTIFIED IDENTIFYING CONCRETE WASHDOWN AREA .5. CONTRACTOR SHALL USE HIGH PRESSURE LOW YOLUME NOZZLE FOR WASHING.

6. NO CONCRETE DRUM WASHOUT IS ALLOWED ON SITE.


BALES SHALL BE INSPECTED FREQUENTLY AND REPAIRED AND/OR REPLACED PROMPTLY AS NEEDED. BALES SHALL BE REMOVED

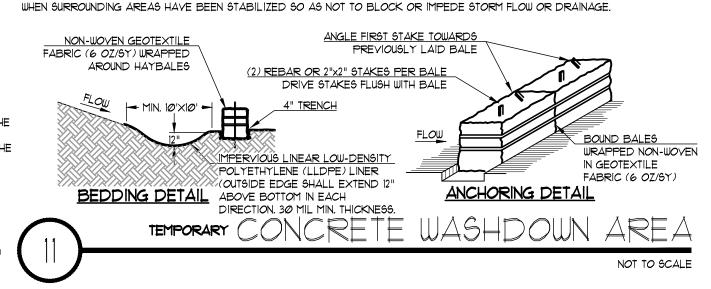

CHANNEL SHALL BE INSPECTED REGULARLY. ACCUMULATED DEBRIS SHALL BE REMOVED IMMEDIATELY.

REFER TO CALCULATIONS FOR CHANNEL HYDRAULICS. D63 AND/OR D64 CHANNEL WIDTH REFER TO PLAN(S) 25-YEAR DEPTH: 6" 25-YEAR FLOW: 12.38 CF6

TEMPORARY AND CHANNEL STABILIZATION VEGETATIVE LINING NOT TO SCALE 208 Pirkle Ferry Road, Suite C Cumming, GA 30040

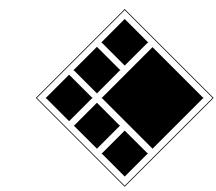

BREEDLOVE LAND PLANNING Landscape Architects ◆ Civil Engineers 15 Simpson Street, NW, Atlanta, GA 30308 P: 770-483-1173 ◆ www.landplanning.net

BLP PROJ. NO. 22158



COUN ROCKDALE TRAIINNG C

PRINT RECORD

No. DATE **DESCRIPTION** 1 07/31/2023 LDP SUBMITTAL 2 09/07/2023 LDP RESUBMITTAL 3 10/12/2023 LDP RESUBMITTAL 4 01/16/2024 LDP RESUBMITTAL

ROCKDALE COUN COMMISSIONERS

Drawn By **Checked By** Job No. Date

Sheet Title

ES&PC DETAILS

Sheet No.

DO NOT BREAK OR DUPLICATE

24-HOUR EROSION CONTACT

7-DAY LETTER CERTIFICATION

COMPLETION OF THE INITIAL INSPECTION PER NPDES REQUIREMENTS.

CERTIFIED DESIGN PROFESSIONAL: JUSTIN M TANNER

GSWCC CERTIFICATION NO. LEVEL 11 * 0000029448

COMPANY: BREEDLOVE LAND PLANNING, INC.

EXPIRATION DATE: Ø3-29-2024

PHONE NUMBER: 618-381-1081

SIGNED:

COMPANY:

THE BELOW SIGNATURE VERIFIES THAT A 1-DAY LETTER WILL BE CERTIFIED UPON

GSWCC CHECKLIST LEGEND

GSWCC CHECKLIST ITEM NUMBER

1. DO NOT DUPLICATE DRAWINGS WITHOUT PERMISSION.

ROCKDALE COUNTY BOC

EMAIL ADDRESS: ANDREW.HAMMER@ROCKDALECOUNTYGA.GOV

READ THE SPECIFICATIONS. THIS SET OF DRAWINGS AND SPECIFICATIONS DEFINE PROJECT SCOPE AND CONTRACT REQUIREMENTS. INDIVIDUAL SHEETS SEPARATED FROM THE SET MAY NOT ADEQUATELY REFLECT ALL INFORMATION NEEDED TO SUITABLY COVER CERTAIN ITEMS. DO NO SEPARATE THIS SET OF DRAWINGS INTO INDIVIDUAL SHEETS.

2' OF 24" STANDPIPE WITH 3/4" HOLES BURNED 6" O.C.E.W. WELDED TO METAL PLATE *** 51 GRAVEL FILTER CONE** PROVIDE TEMPORARY 2" WEEP OPENING UNTIL STRUCTURE TOP AND FINISHED GRADE IS ACHIEVED THEN GROUT CLOSED. LENGTH REFER TO Sd2-E CHART FOR DIMENSIONS CONTRACTOR'S OPTION TO JTILIZE SILT-SAVER IN LIEU OF STANDPIPE AND GRAVEL SECTION FILTER CONE SILT-SAVER *

STORM WATER FILTER & SAFETY GUARD www.siltsaver.com 1401 Business Center Drive Conyers, GA 30094 Phone: (770) 388-7818 Fax: (770) 388-7640 Toll Free: 1-888-382-51LT (7458)

* OR APPROVED EQUAL


BRARBBRARBBRARB

EXCAVATED TEMPORARY (Sd2-Alt) INLET SEDIMENT TRAP NOT TO SCALE

TRIPLE-LAYER OF JUTE FABRIC MATTING DRAPED OVER ENTIRE TOP OF OUTLET PROTECTION, INSTALLED SAME DAY AS OUTLET PROTECTION, PER TECHNICAL SPECIFICATIONS. EXTEND STORM DRAIN OUTLET REFER TO St. CHART FOR DIMENSIONS. 2. do = DIAMETER OF INLET PIPE 3. d50 = MINIMUM STONE DIAMTER 4. dmax = MAXIMUM STONE DIAMETER = 1.5 * d50 5. D = 1.5 * do (MIN. 6") 6. EXTEND RIP RAP UPSTREAM TO TOP OF CHANNEL BANK. 1. INSTALL FILTER BLANKET BETWEEN RIP RAP AND SOIL FOUNDATION. FILTER BLANKET SHALL CONSIST OF GRADED GRAVEL LAYER OR SYNTEHTIC FILTER CLOTH. 8. RIP RAP APRON AND FILTER BLANKET SHALL

BE GRADED LEVEL AND EXTENDED TO ACHIEVE MAXIMUM STABILITY. TRENCH & BURY EDGE OF RIP RAP SHALL BE INSPECTED AFTER LARGE JUTE FABRIC 6" DEEP RAIN EVENTS, REPAIRS SHALL BE MADE IMMEDIATELY. OUTLET PROTECTION.

FINISHED GRADE SECTION FILTER BLANKET TEMPORARY STORM DRAIN OUTLET PROTECTION MINIMUM TAILWATER CONDITION NOT TO SCALE

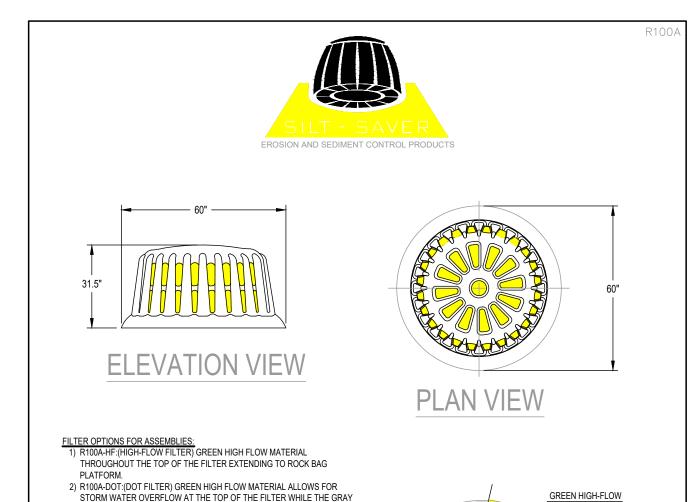

HALF OF THE FILTER EXTENDING TO THE ROCK BAG PLATFORM. IT IS THE PURCHASERS RESPONSIBILITY TO SELECT APPROPRIATE FILTER. FILTER INSTALLATION
FILTER SHOULD BE PLACED OVER FRAME. POCKETS ON THE EDGES OF THE FILTER SHOULD BE FILLED WITH ROCK. INSTALLER SHALL PROVIDE ROCK FOR FILTER POCKETS

HIGH EFFICIENCY SEDIMENT FILTRATION FABRIC COVERS THE BOTTOM

ALL TEMPORARY EROSION, SEDIMENTATION, & POLLUTION CONTROL PRACTICES SHOULD BE INSPECTED DAILY. CONTRACTOR SHALL

REMOVE SEDIMENT AND DISPOSE OF IN A PROPER MANNER. INSPECT

FRAME AND FILTER DAILY FOR CUTS, ABRASIONS, AND PROPER INSTALLATION. REPLACE OR REPOSITION AS NECESSARY. REPLACEMENT FILTERS: MODEL # R-140HF OR R-140DOT

ROUND BASE FRAME & FILTER ASSEMBLY 60" DIAMETER AKA "SS-100A (Round)" Model # R-100A

FRAME MATERIAL: BLACK PE FILTER FABRIC MATERIAL: REFER TO SPEC SCALE: NOT TO SCALE LAST UPDATED: MARCH 2021

AY HIGH-EFFICIENCY

NOT TO SCALE


POCKET FILLED w/ ROCK FOR WEIGHT

PURCHASER.

ROCK PROVIDED BY

SILT-SAVER, INC. 1200 FORRESTER CEMETERY RD, COVINGTON, GA 30014 PHONE: (770) 388-7818 FAX: (770) 388-7640 TOLL FREE: 1-888-382-SILT (7458) www.siltsaver.com

REFER TO PLANS AND CALCULATIONS SHEET FOR SEDIMENT STORAGE PROVISIONS FOR EACH SPECIFIC APPLICATION OF THIS BEST MANAGEMENT PRACTICE (BMP)

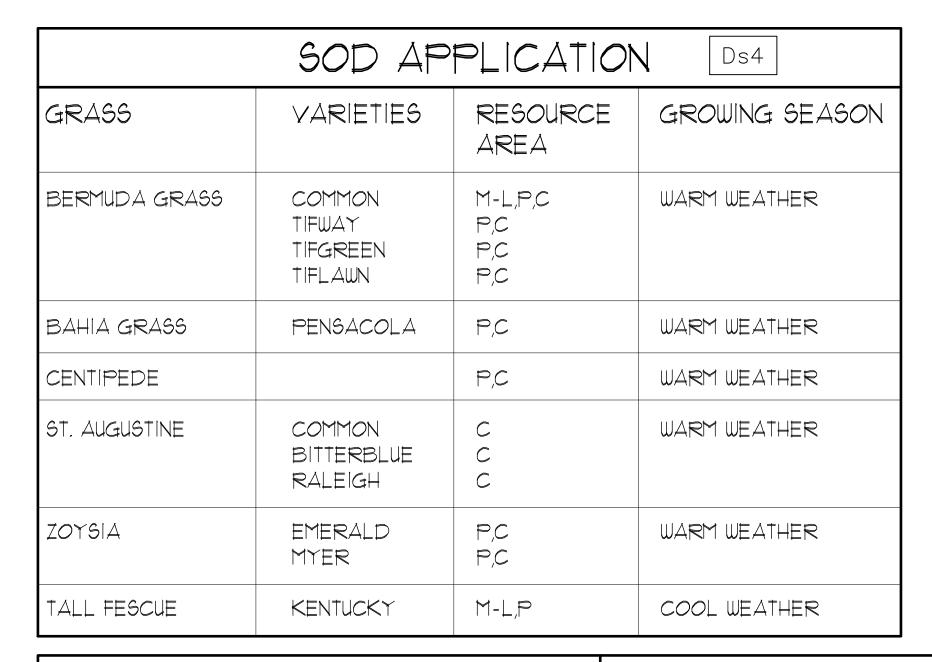

PIEDI	MONT VEG	ETATIV	E COVERS	3	SOIL AME	NDMENTS	(51)
MONTH	TEMPORARY Ds2	RATE / ACRE ALONE - MIX	PERMANENT Ds3	RATE / ACRE ALONE - MIX	LIME	6-12-12	AMMONIA NITRATE
JANUARY	RYE GRASS	4Ø LBS	UNHULLED BERMUDA SERICEA LESPEDEZA	10 LBS - 8 LBS 40 LBS - 30 LBS	60 LBS PER 1000 SQFT.	40 LBS PER 1000 SQFT.	300 LBS PER ACRE
FEBRUARY	RYE GRASS	40 LBS	UNHULLED BERMUDA SERICEA LESPEDEZA (2) FESCUE	10 LBS - 8 LBS 40 LBS - 30 LBS 50 LBS - 40 LBS	60 LB\$ PER 1000 \$QFT.	40 LBS PER 1000 SQFT.	300 LBS PER ACRE
MARCH	RYE GRASS ANNUAL LESPEDEZA (2) WEEPING LOVEGRASS	2-3 BU 30 LBS - 25 LBS 4 LBS - 2 LBS	UNHULLED BERMUDA SERICEA LESPEDEZA (12) FESCUE	10 LBS - 8 LBS 40 LBS - 30 LBS 50 LBS - 40 LBS	60 LBS PER 1000 SQFT.	40 LB5 PER 1000 5QFT.	300 LBS PER ACRE
APRIL	ANNUAL LESPEDEZA (2) RYE BROWN TOP MILLET SUDAN GRASS	30 LBS - 25 LBS 3 BU - 0.5 BU 40 LBS - 30 LBS 35 LBS	WEEPING LOVEGRASS HULLED BERMUDA BAHIA	6 LBS - 6 LBS 10 LBS - 8 LBS 60 LBS - 40 LBS	60 LB\$ PER 1000 SQFT.	40 LB5 PER 1000 5QFT.	300 LBS PER ACRE
МАТ	WEEPING LOVEGRASS SUDAN GRASS BROWN TOP MILLET				60 LB\$ PER 1000 SQFT,	40 LB5 PER 1000 SQ.FT.	300 LBS PER ACRE
JUNE	WEEPING LOVEGRASS SUDAN GRASS BROWN TOP MILLET	6 LB9 - 6 LB9 35 LB9 40 LB9 - 15 LB9	WEEPING LOVEGRASS HULLED BERMUDA BAHIA	6 LB6 - 6 LB6 10 LB6 - 8 LB6 60 LB6 - 40 LB6	60 LB\$ PER 1000 \$QFT.	40 LBS PER 1000 SQFT.	300 LBS PER ACRE
JULY	SAME AS JUNE	6 LB6 - 6 LB6 35 LB6 40 LB6 - 15 LB6	WEEPING LOVEGRASS HULLED BERYUDA BAHIA	6 LB6 - 6 LB6 10 LB6 - 8 LB6 60 LB6 - 40 LB6	60 LB\$ PER 1000 SQFT,	40 LB5 PER 1000 5Q.FT.	300 LBS PER ACRE
AUGUST	WEEPING LOVEGRASS RYE GRASS	6 LBS - 6 LBS 40 LBS			60 LBS PER 1000 SQFT.	40 LBS PER 1000 SQ.FT.	300 LBS PER ACRE
SEPTEMBER			FE9CUE	50 LBS - 30 LBS	60 LB\$ PER 1000 \$QFT.	40 LBS PER 1000 SQFT.	300 LBS PER ACRE
OCTOBER	WHEAT	3 BU - Ø.5 BU	UNHULLED BERMUDA SERICEA LESPEDEZA (2) FESCUE	10 LB\$ - 8 LB\$ 40 LB\$ - 30 LB\$ 50 LB\$ - 40 LB\$	60 LB\$ PER 1000 \$QFT.	40 LBS PER 1000 SQFT.	300 LBS PER ACRE
NOVEMBER	SAME AS OCTOBER		SAME AS OCTOBER	SAME AS OCTOBER	60 LB\$ PER 1000 \$QFT.	40 LBS PER 1000 SQFT.	300 LBS PER ACRE
DECEMBER	SAME AS OCTOBER		SAME AS OCTOBER	SAME AS OCTOBER	60 LBS PER 1000 SQFT,	40 LB5 PER 1000 5QFT.	300 LBS PER ACRE
1. SEED SHALL	SEED SHALL BE SCARIFIED. 2. SEED SHALL BE INOCULATED.					HIS CHART ARE A RECOMMENDED AMENDMENTS AS IDENTIFIED BY	


Ds3 Ds2

VEGETATIVE PLAN- PIEDMONT VEGETATIVE COVERS


MULCHIN	G APPLICATI	ON Ds1 52
MATERIAL	RATE	DEPTH
STRAW OR HAY	21/2 TON PER ACRE	6"-10"
WOOD WASTE, CHIPS, SAWDUST, BARK	6-9 TON PER ACRE	2"-3"

FOR FINAL STABILIZATION BED MULCH, CONTRACTOR SHALL PROVIDE MIN 3" CLEAN PINE NEEDLES, SEE PLANTING DETAILS ON C701

MULCHING APPLICATION TABLE NOT TO SCALE

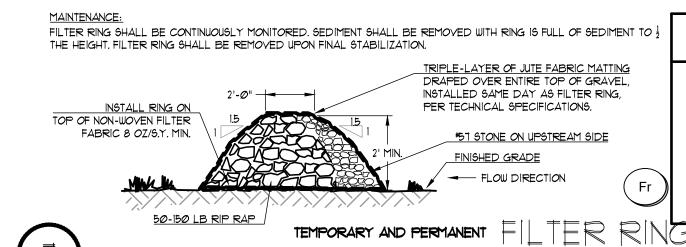

7-DAY LETTER CERTIFICATION

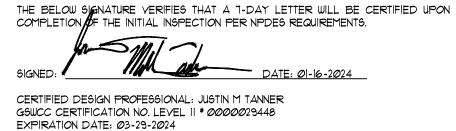

COMPANY: BREEDLOVE LAND PLANNING, INC.

NOT TO SCALE

GSWCC CHECKLIST LEGEND

GSWCC CHECKLIST ITEM NUMBER

7	YPE OF SPECIES	YEAR	ANALYSIS OR EQUIVALENT N-P-K	RATE	N TOP DRESSING RATE
1.	Cool season	First	6-12-12	1500 lbs./ac.	50-100 lbs./ac. 1/2/
	grasses	Second Maintenance	6-12-12 10-10-10	1000 lbs./ac. 400 lbs./ac.	30
2	Cool season	First	6-12-12	1500 lbs./ac.	0-50 lbs./ac. 1/
	grasses and	Second	0-10-10	1000 lbs./ac.	0 00 100 1100 11
	legumes	Maintenance	0-10-10	400 lbs./ac.	_
3.	Ground covers	First	10-10-10	1300 lbs./ac. 3/	
		Second	10-10-10	1300 lbs./ac. 3/	
		Maintenance	10-10-10	1100 lbs./ac.	_
4.	Pine seedlings	First	20-10-5	one 21-gram pellet per seedling placed in the closing hole	-
5	Shrub Lespedeza	First	0-10-10	700 lbs./ac.	
٠.	om ab Ecopodoza	Maintenance	0-10-10	700 lbs./ac. 4/	
6.	Temporary cover crops seeded alone	First	10-10-10	500 lbs./ac.	30 lbs./ac. 5/
7.	Warm season	First	6-12-12	1500 lbs./ac.	50-100 lbs./ac. 2/6
	grasses	Second	6-12-12	800 lbs./ac.	50-100 lbs./ac. 2/
		Maintenance	10-10-10	400 lbs./ac.	30 lbs./ac.
8.	Warm season	First	6-12-12	1500 lbs./ac.	50 lbs./ac./6/
	grasses and	Second	0-10-10	1000 lbs./ac.	
	legumes	Maintenance I	0-10-10	400 lbs./ac.	

Table 6-5.1. Fertilizer Requirements

1/ Apply in spring following seeding.

2/ Apply in split applications when high rates are used.

3/ Apply in 3 split applications.

4/ Apply when plants are pruned.

*In NC assume 3 days to drain

FLOAT

*SKIMMER SHALL BE

(Sk)

OR APPROVED EQUAL*

FAIRCLOTH, MARLEY FLOAT

TEMPORARY

PHONE NUMBER: 678-387-7081

5/ Apply to grass species only. 6/ Apply when plants grow to a height of 2 to 4 inches.

Calculate Skimmer Size 90,100 Cu.Ft Basin Volume in Cubic Feet Days to Drain*

> WATER ENTRY UNIT WITH TRASH SCREEN

ORIFICE OPENING INSIDE THE HORIZONTAL TUBE WITH A CONSTANT HYDRAULIC HEAD

OUTLET PIPE

SHALL BE 2.5" ORFICE DIAMETER WITH 3" SKIMMER.

3" SCHEDULE 40 PVC PIPE

BARREL OR ARM)

FLEXIBLE HOSE

PVC VENT PIPE

WATER ENTRY UNIT

Skimmer Size Orifice Radius Orifice Diameter

MAXIMUM HEIGHT OF FLOAT WHEN NO OTHER STORM WATER DISCHARGE OPENINGS EXIST

INVERT OF LOWEST STORM WATER

(MINOR STORM EVENT) ELEVATION

BOTTOM OF SD3 AND LOWEST ORFICE

(MAJOR STORM EVENT)

DISCHARGE OPENING

FLEXIBLE HOSE MUST BE

FLEXIBLE HOSE

SECURELY FASTENED TO THE

WATER QUALITY DISCHARGE

<u>GENERAL NOTES:</u>
I. PROPER DESIGN MUST BE COMPLETED TO MINIMIZE PIPING: AROUND DISCHARGE PIPE.

MODIFICATIONS MAY BE REQUIRED IF FIELD CONDITIONS WARRANT A CHANGE.

3. EMBANKMENT MUST BE COMPACTED TO DESIGN SPECIFICATIONS

ACCUMULATION. SEDIMENT SHALL BE REMOVED WHEN BASIN IS $\frac{1}{3}$ FULL.

2"X4" PT WOOD GUIDE

STAKES

MAINTAIN DEPRESSION TO

BECOMING STUCK

MINIMIZE CHANCE OF SKIMMER

EARTHEN EMBANKMENT

GRATE

SKIMMER WITH OUTLET CONTROL STRUCTURE

EMERGENCY SPILLWAY

STORM WATER

DISCHARGE

2. PROPER ORIFICE OPENING MUST BE SELECTED TO ENSURE POND DRAINS IN CORRECT AMOUNT OF TIME.

MAINTENANCE:
SKIMMER SHALL BE MAINTAINED PER MANUFACTURER'S RECOMMENDATIONS, INSPECT BASIN DAILY AND AFTER LARGE STORM EVENTS FOR STRUCTURAL DAMAGE, CLOGGING, OR EXCESSIVE SEDIMENT

4. EMERGENCY SPILLWAY MUST BE CORRECTLY SIZED AND EROSION PROTECTION INSTALLED.
5. EROSION PROTECTION MUST BE INSTALLED ALONG THE EMBANKMENT AND AT THE DISCHARGE END OF THE PIPE.

6 INSPECT SYSTEM REGULARLY TO ENSURE IT IS FUNCTIONING IN A CORRECT MANNER.

1 EIGHT SIZES OF SKIMMERS ARE AVAILABLE, REFER TO THE FLOW SHEET, CUT SHEET, AND INSTRUCTIONS ON WEB SITE.

6.0 Inch 2.8 Inch[es] 5.6 Inch[es]

PYC YENT

- FLOAT

PIPE

L = 1.4 × DEPTH

TO THE OVERFLOW

MINIMUM LENGTH APPLIES

(BARREL OR ARM)

SCHEDULE 40 PVC PIPE

BLOCK

CMU RESTING

COUN' AMPU ROCKDALE TRAIINNG C

~

ROCKDALE COUN COMMISSIONERS

OF

designgroup

208 Pirkle Ferry Road, Suite C

Cumming, GA 30040

BREEDLOVE LAND PLANNING

Landscape Architects ◆ Civil Engineers

15 Simpson Street, NW, Atlanta, GA 30308

P: 770-483-1173 ◆ www.landplanning.net

BLP PROJ. NO. 22158

No.	DATE	DESCRIPTION
1	07/31/2023	LDP SUBMITTAL
2	09/07/2023	LDP RESUBMITTAL
3	10/12/2023	LDP RESUBMITTAL
4	01/16/2024	LDP RESUBMITTAL

Drawn By **Checked By** BAM Job No. Date 05/05/2023

Sheet Title

ES&PC DETAILS

Sheet No.

NOT RELEASED FOR CONSTRUCTION

ROCKDALE COUNTY BOC

EMAIL ADDRESS: ANDREW.HAMMER@ROCKDALECOUNTYGAGOV

READ THE SPECIFICATIONS. THIS SET OF DRAWINGS AND SPECIFICATIONS DEFINE PROJECT SCOPE AND CONTRACT REQUIREMENTS. INDIVIDUAL SHEETS SEPARATED FROM THE SET MAY NOT ADEQUATELY REFLECT ALL INFORMATION NEEDED TO SUITABLY COVER CERTAIN ITEMS. DO NO SEPARATE THIS SET OF DRAWINGS INTO INDIVIDUAL SHEETS.

SEPTIC CALCULATIONS

DESIGN FLOW & DISPOSAL FIELD SIZING:

• SYSTEM DESIGN BASED ON PROPOSED USE AS:

RESTROOM BUILDING DESIGN FLOW RATIONALE:

35 PERSONS AT I TIME AT FACILITY 35 PERSONS X 10 GPD = 350 GPD

DRAIN FIELD (PRIMARY & REPLACEMENT) CALCULATIONS::

• SOIL TYPE: WEDOWEE/PACOLET (LEVEL 3 SOIL SURVEY BY MATRIX ENGINEERING) DESIGN PERCOLATION RATE: 45 MPI INSTALL DEPTH: 30"

DRAIN FIELD AREA: DESIGN FLOW / LOADING RATE = 350 GPD / 0.745 GPD/SF = 470 SF DRAIN LINE REQUIRED: 470 SF / 3FT TRENCH = 151 LINEAR FEET (MIN.)

PRIMARY DRAIN FIELD: (PRODUCT: HI-CAPACITY CHAMBER PRODUCT, 35% REDUCTION) 157 FT x 0.65 = 103 LINEAR FEET (MINIMUM)

REPLACEMENT DRAIN FIELD: (FULL LENGTH PRODUCT, NO REDUCTION) 160 LINEAR FEET (MINIMUM) AS SHOWN ON PLANS

DRAIN FIELD SPECIFICATIONS:

PRIMARY:

GRAVITY FLOW @ MIN. 1.0% TO LEVEL FIELD DRAIN FIELD

PRODUCT: HI-CAPACITY CHAMBER PRODUCT

TOTAL DRAIN FIELD SHOWN: 110 LINEAR FEET DRAIN FIELD ORIENTATION MAY BE FIELD ADJUSTED TO AVOID TREES BUT MUST INCLUDE LENGTH OF TRENCH AND PRODUCT SPECIFIED ABOVE.

EQUAL DISTRIBUTION, 30" TRENCH DEPTH
(2) TRENCHES © 55FT EACH FOR A TOTAL OF 110 LINEAR FEET FULL LENGTH PRODUCT, REGARDLESS TYPE. (NO REDUCTIONS.)

ROCKDALE COUNTY NOTES

DESIGN AND CONSTRUCTION OF ALL WATER AND SANITARY SEWER LINES SHALL CONFORM TO ROCKDALE WATER RESOURCES WATER AND WASTEWATER STANDARDS AND SPECIFICATIONS, LATEST EDITION.

CONTRACTOR WILL NOTIFY RW.R. ENGINEERING DEPARTMENT AT LEAST 12 HOURS PRIOR TO BEGINNING OF CONSTRUCTION ON WATER AND SEWER. AND INSPECTOR WILL BE ASSIGNED AND A PRE-CONSTRUCTION MEETING SCHEDULED AT THIS TIME.

"AS-BUILT" DRAWINGS SHALL BE FIELD VERIFIED AND STAMPED BY A REGISTERED PROFESSIONAL ENGINEER OR LAND SURVEYOR, LICENSED IN THE STATE OF GEORGIA.

THE CONTRACTOR SHALL COMPLY WITH ALL UTILITIES PROTECTION CENTER REQUIREMENTS.

GENERAL NOTES

PROPOSED BUILDING USE: BURN BUILDING CONTRACTOR SHALL VERIFY CONDITIONS AND DIMENSIONS BEFORE PROCEEDING WITH CONSTRUCTION. ANY DISCREPANCIES FOUND SHALL BE REPORTED TO THE OWNER FOR CLARIFICATION AND/OR CORRECTION BEFORE PROCEEDING WITH THE WORK. CONTRACTOR SHALL ASSUME RESPONSIBILITY FOR DISCREPANCIES WHICH ARE NOT REPORTED.

CONTRACTOR SHALL STAKE ALL BLEACHER AND FOUNDATION CORNERS AND OBTAIN OWNER'S APPROVAL BEFORE POURING ANY FOOTINGS.

CONTRACTOR SHALL HAVE PRIVATE UTILITY LOCATE PERFORMED THROUGHOUT PROJECT AREA PRIOR TO BEGINNING ANY CONSTRUCTION.

4. CONTRACTOR SHALL BE RESPONSIBLE FOR ANY REQUIRED PERMITS AND ANY REQUIREMENTS NECESSARY TO OBTAIN CERTIFICATE OF OCCUPANCY.

CONTRACTOR SHALL BE RESPONSIBLE FOR ENSURE ADA ACCESSIBILITY.

24-HOUR EROSION CONTACT

ANDREW HAMMER ROCKDALE COUNTY BOC COMPANY: EMAIL ADDRESS: ANDREW.HAMMER@ROCKDALECOUNTYGAGOV

GRAPHIC SCALE & ORIENTATION



UTILITY LOCATION NOTES

CONTRACTOR SHALL BE RESPONSIBLE TO SECURE THE SERVICES OF A PRIVATE UTILITY LOCATOR FIRM DURING THE ENTIRE COURSE OF CONSTRUCTION. CONTRACTOR SHALL PAY FOR SAID SERVICES.

CONTRACTOR SHALL IMMEDIATELY REPAIR ALL UTILITIES DAMAGED BY CONSTRUCTION ACTIVITIES, AT NO ADDITIONAL COST TO THE OWNER.

THE UTILITIES SHOWN ARE SCHEMATIC AND FOR THE CONTRACTOR'S CONVENIENCE ONLY. THERE MAY BE OTHER UTILITIES NOT SHOWN ON THESE PLANS. THE DESIGN PROFESSIONAL ASSUMES NO RESPONSIBILITY FOR THE LOCATIONS SHOWN AND IT SHALL BE THE CONTRACTOR'S RESPONSIBILITY TO VERIFY THE LOCATIONS OF UTILITIES WITHIN THE LIMITS OF THE WORK. DAMAGE TO EXISTING UTILITIES BY THE CONTRACTOR, FROM HIS/ HER OPERATIONS SHALL BE IMMEDIATELY REPAIRED AT NO ADDITIONAL COST TO THE OWNER.

CONTRACTOR SHALL BE RESPONSIBLE FOR COMPACTION OF BACKFILL OF ALL UTILITY TRENCHES WITHIN SITE WORK LIMITS. THIS INCLUDES TRENCHES DUG AND BACKFILLED BY LOCAL UTILITIES, SUCH AS POWER, GAS, TELEPHONE, ETC. CONTRACTOR SHALL PROVIDE ADDITIONAL BACKFILL AND COMPACTION AS NECESSARY, IF SETTLEMENT OCCURS.




GEORGIA LAW MANDATES THAT, BEFORE BEGINNING ANY MECHANIZED DIGGING OR EXCAVATION WORK, YOU MUST CONTACT GEORGIA 811 BY USING EREQUEST ON WWW.GEORGIA811.COM OR BY CALLING 811 OR 1-800-282-7411 AT LEAST 48 HOURS BUT

READ THE SPECIFICATIONS. THIS SET OF DRAWINGS AND SPECIFICATIONS DEFINE PROJECT SCOPE AND CONTRACT REQUIREMENTS. INDIVIDUAL SHEETS SEPARATED FROM THE SET MAY NOT ADEQUATELY REFLECT ALL INFORMATION NEEDED TO SUITABLY COVER CERTAIN ITEMS. DO NO SEPARATE THIS SET OF



208 Pirkle Ferry Road, Suite C Cumming, GA 30040

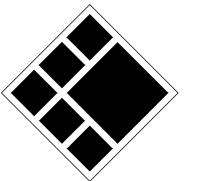

BREEDLOVE LAND PLANNING Landscape Architects ◆ Civil Engineers 15 Simpson Street, NW, Atlanta, GA 30308 P: 770-483-1173 ◆ www.landplanning.net

BLP PROJ. NO. 22158



ROCKDALE COUN COMMISSIONERS

ROCKDALE (TRAIINNG CA

No.	DATE	DESCRIPTION
1	07/31/2023	LDP SUBMITTAL
2	09/07/2023	LDP RESUBMITTAL
3	10/12/2023	LDP RESUBMITTAL
4	01/16/2024	LDP RESUBMITTAL

Drawn By Checked By Date Job No. 05/05/2023

Sheet Title

UTILITY PLAN

Sheet No.

NOT RELEASED FOR CONSTRUCTION

CALL BEFORE YOU DIG

NO MORE THAN 10 WORKING DAYS IN ADVANCE TO HAVE UTILITY LINES MARKED.

DO NOT BREAK OR DUPLICATE

I. DO NOT DUPLICATE DRAWINGS WITHOUT PERMISSION.

DRAWINGS INTO INDIVIDUAL SHEETS.

TREE CALCULATIONS

(ONLY TREES 24" AND LARGER WERE SURVEYED.)

(ONLY TREES 24" AND LARGER WERE SURVEYED.)

OF FOREST ARE TO REMAIN UNDISTURBED.

CALCULATIONS ARE BASED ONLY ON TREES 24" AND LARGER.
890.00 UNITS REMAIN ON SITE. SITE VISITS GIVE REASON TO BELIEVE
MORE THAN 121.45 UNITS ARE TO BE PRESERVED ON SITE. 59.28 ACRES

- CONTRACTOR WILL NOTIFY RW.R ENGINEERING DEPARTMENT AT LEAST 12
- "AS-BUILT" DRAWINGS SHALL BE FIELD VERIFIED AND STAMPED BY A REGISTERED PROFESSIONAL ENGINEER OR LAND SURVEYOR, LICENSED IN
- REQUIREMENTS.

- OBTAIN OWNER'S APPROVAL BEFORE POURING ANY FOOTINGS.
- PROJECT AREA PRIOR TO BEGINNING ANY CONSTRUCTION.
- REQUIREMENTS NECESSARY TO OBTAIN CERTIFICATE OF OCCUPANCY.
- 5. CONTRACTOR SHALL BE RESPONSIBLE FOR ENSURE ADA ACCESSIBILITY.

24-HOUR EROSION CONTACT

EMAIL ADDRESS: ANDREW.HAMMER@ROCKDALECOUNTYGAGOV PHONE NUMBER: 678-387-7081

GRAPHIC SCALE & ORIENTATION

CONTRACTOR SHALL BE RESPONSIBLE TO SECURE THE SERVICES OF A PRIVATE UTILITY LOCATOR FIRM DURING THE ENTIRE COURSE OF CONSTRUCTION. CONTRACTOR SHALL PAY FOR SAID SERVICES.

- CONTRACTOR SHALL IMMEDIATELY REPAIR ALL UTILITIES DAMAGED BY CONSTRUCTION ACTIVITIES, AT NO ADDITIONAL COST TO THE OWNER.
- THE UTILITIES SHOWN ARE SCHEMATIC AND FOR THE CONTRACTOR'S CONVENIENCE ONLY. THERE MAY BE OTHER UTILITIES NOT SHOWN ON THESE PLANS. THE DESIGN PROFESSIONAL ASSUMES NO RESPONSIBILITY FOR THE LOCATIONS SHOWN AND IT SHALL BE THE CONTRACTOR'S RESPONSIBILITY TO VERIFY THE LOCATIONS OF UTILITIES WITHIN THE LIMITS OF THE WORK. DAMAGE TO EXISTING UTILITIES BY THE CONTRACTOR, FROM HIS/ HER OPERATIONS SHALL BE IMMEDIATELY REPAIRED AT NO ADDITIONAL COST TO THE OWNER.
- CONTRACTOR SHALL BE RESPONSIBLE FOR COMPACTION OF BACKFILL OF ALL UTILITY TRENCHES WITHIN SITE WORK LIMITS. THIS INCLUDES TRENCHES DUG AND CONTRACTOR SHALL PROVIDE ADDITIONAL BACKFILL AND COMPACTION AS NECESSARY, IF SETTLEMENT OCCURS.

CALL BEFORE YOU DIG



GEORGIA LAW MANDATES THAT, BEFORE BEGINNING ANY MECHANIZED DIGGING OR EXCAVATION WORK, YOU MUST CONTACT GEORGIA 811 BY USING EREQUEST ON WWW.GEORGIA811.COM OR BY CALLING 811 OR 1-800-282-7411 AT LEAST 48 HOURS BUT NO MORE THAN 10 WORKING DAYS IN ADVANCE TO HAVE UTILITY LINES MARKED.

DRAWINGS INTO INDIVIDUAL SHEETS.



OVERALL DENSITY FACTOR (ODF) = UNITS PER ACRE REQUIRED = 15.00 UNITS TOTAL PROJECT AREA = 61.43 ACRES

67.43 × 15.00 = <u>1011.45 ODF</u>

EXISTING DENSITY FACTOR (EDF) = 1070.30 UNITS

TOTAL UNITS REMOVED = 180.30 UNITS (ONLY TREES 24" AND LARGER WERE SURVEYED.)

TOTAL TREE SAVE AREA = 59.30 ACRES TOTAL UNITS REMAINING = 890.00 UNITS

ROCKDALE COUNTY NOTES

DESIGN AND CONSTRUCTION OF ALL WATER AND SANITARY SEWER LINES SHALL CONFORM TO ROCKDALE WATER RESOURCES WATER AND WASTEWATER STANDARDS AND SPECIFICATIONS, LATEST EDITION.

- HOURS PRIOR TO BEGINNING OF CONSTRUCTION ON WATER AND SEWER. AND INSPECTOR WILL BE ASSIGNED AND A PRE-CONSTRUCTION MEETING
- THE STATE OF GEORGIA.
- THE CONTRACTOR SHALL COMPLY WITH ALL UTILITIES PROTECTION CENTER

GENERAL NOTES

PROPOSED BUILDING USE: BURN BUILDING CONTRACTOR SHALL VERIFY CONDITIONS AND DIMENSIONS BEFORE PROCEEDING WITH CONSTRUCTION. ANY DISCREPANCIES FOUND SHALL BE REPORTED TO THE OWNER FOR CLARIFICATION AND/OR CORRECTION BEFORE PROCEEDING WITH THE WORK. CONTRACTOR SHALL ASSUME RESPONSIBILITY FOR DISCREPANCIES WHICH ARE NOT REPORTED.

- CONTRACTOR SHALL STAKE ALL BLEACHER AND FOUNDATION CORNERS AND
- CONTRACTOR SHALL HAVE PRIVATE UTILITY LOCATE PERFORMED THROUGHOUT
- 4. CONTRACTOR SHALL BE RESPONSIBLE FOR ANY REQUIRED PERMITS AND ANY

ANDREW HAMMER ROCKDALE COUNTY BOC COMPANY:





UTILITY LOCATION NOTES

- BACKFILLED BY LOCAL UTILITIES, SUCH AS POWER, GAS, TELEPHONE, ETC.




DO NOT BREAK OR DUPLICATE

- I. DO NOT DUPLICATE DRAWINGS WITHOUT PERMISSION.
- READ THE SPECIFICATIONS. THIS SET OF DRAWINGS AND SPECIFICATIONS DEFINE PROJECT SCOPE AND CONTRACT REQUIREMENTS. INDIVIDUAL SHEETS SEPARATED FROM THE SET MAY NOT ADEQUATELY REFLECT ALL INFORMATION NEEDED TO SUITABLY COVER CERTAIN ITEMS. DO NO SEPARATE THIS SET OF



208 Pirkle Ferry Road, Suite C Cumming, GA 30040

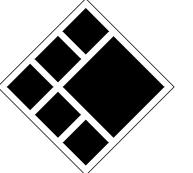

BREEDLOVE LAND PLANNING Landscape Architects ◆ Civil Engineers 15 Simpson Street, NW, Atlanta, GA 30308 P: 770-483-1173 ◆ www.landplanning.net

BLP PROJ. NO. 22158



ROCKDALE COUN COMMISSIONERS


PRINT RECORD				
No.	DATE	DESCRIPTION		
1	07/31/2023	LDP SUBMITTAL		
2	09/07/2023	LDP RESUBMITTAL		
3	10/12/2023	LDP RESUBMITTAL		
4	01/16/2024	LDP RESUBMITTAL		

Drawn By **Checked By** Date Job No. 05/05/2023


Sheet Title

TREE PROTECTION PLAN

Sheet No.

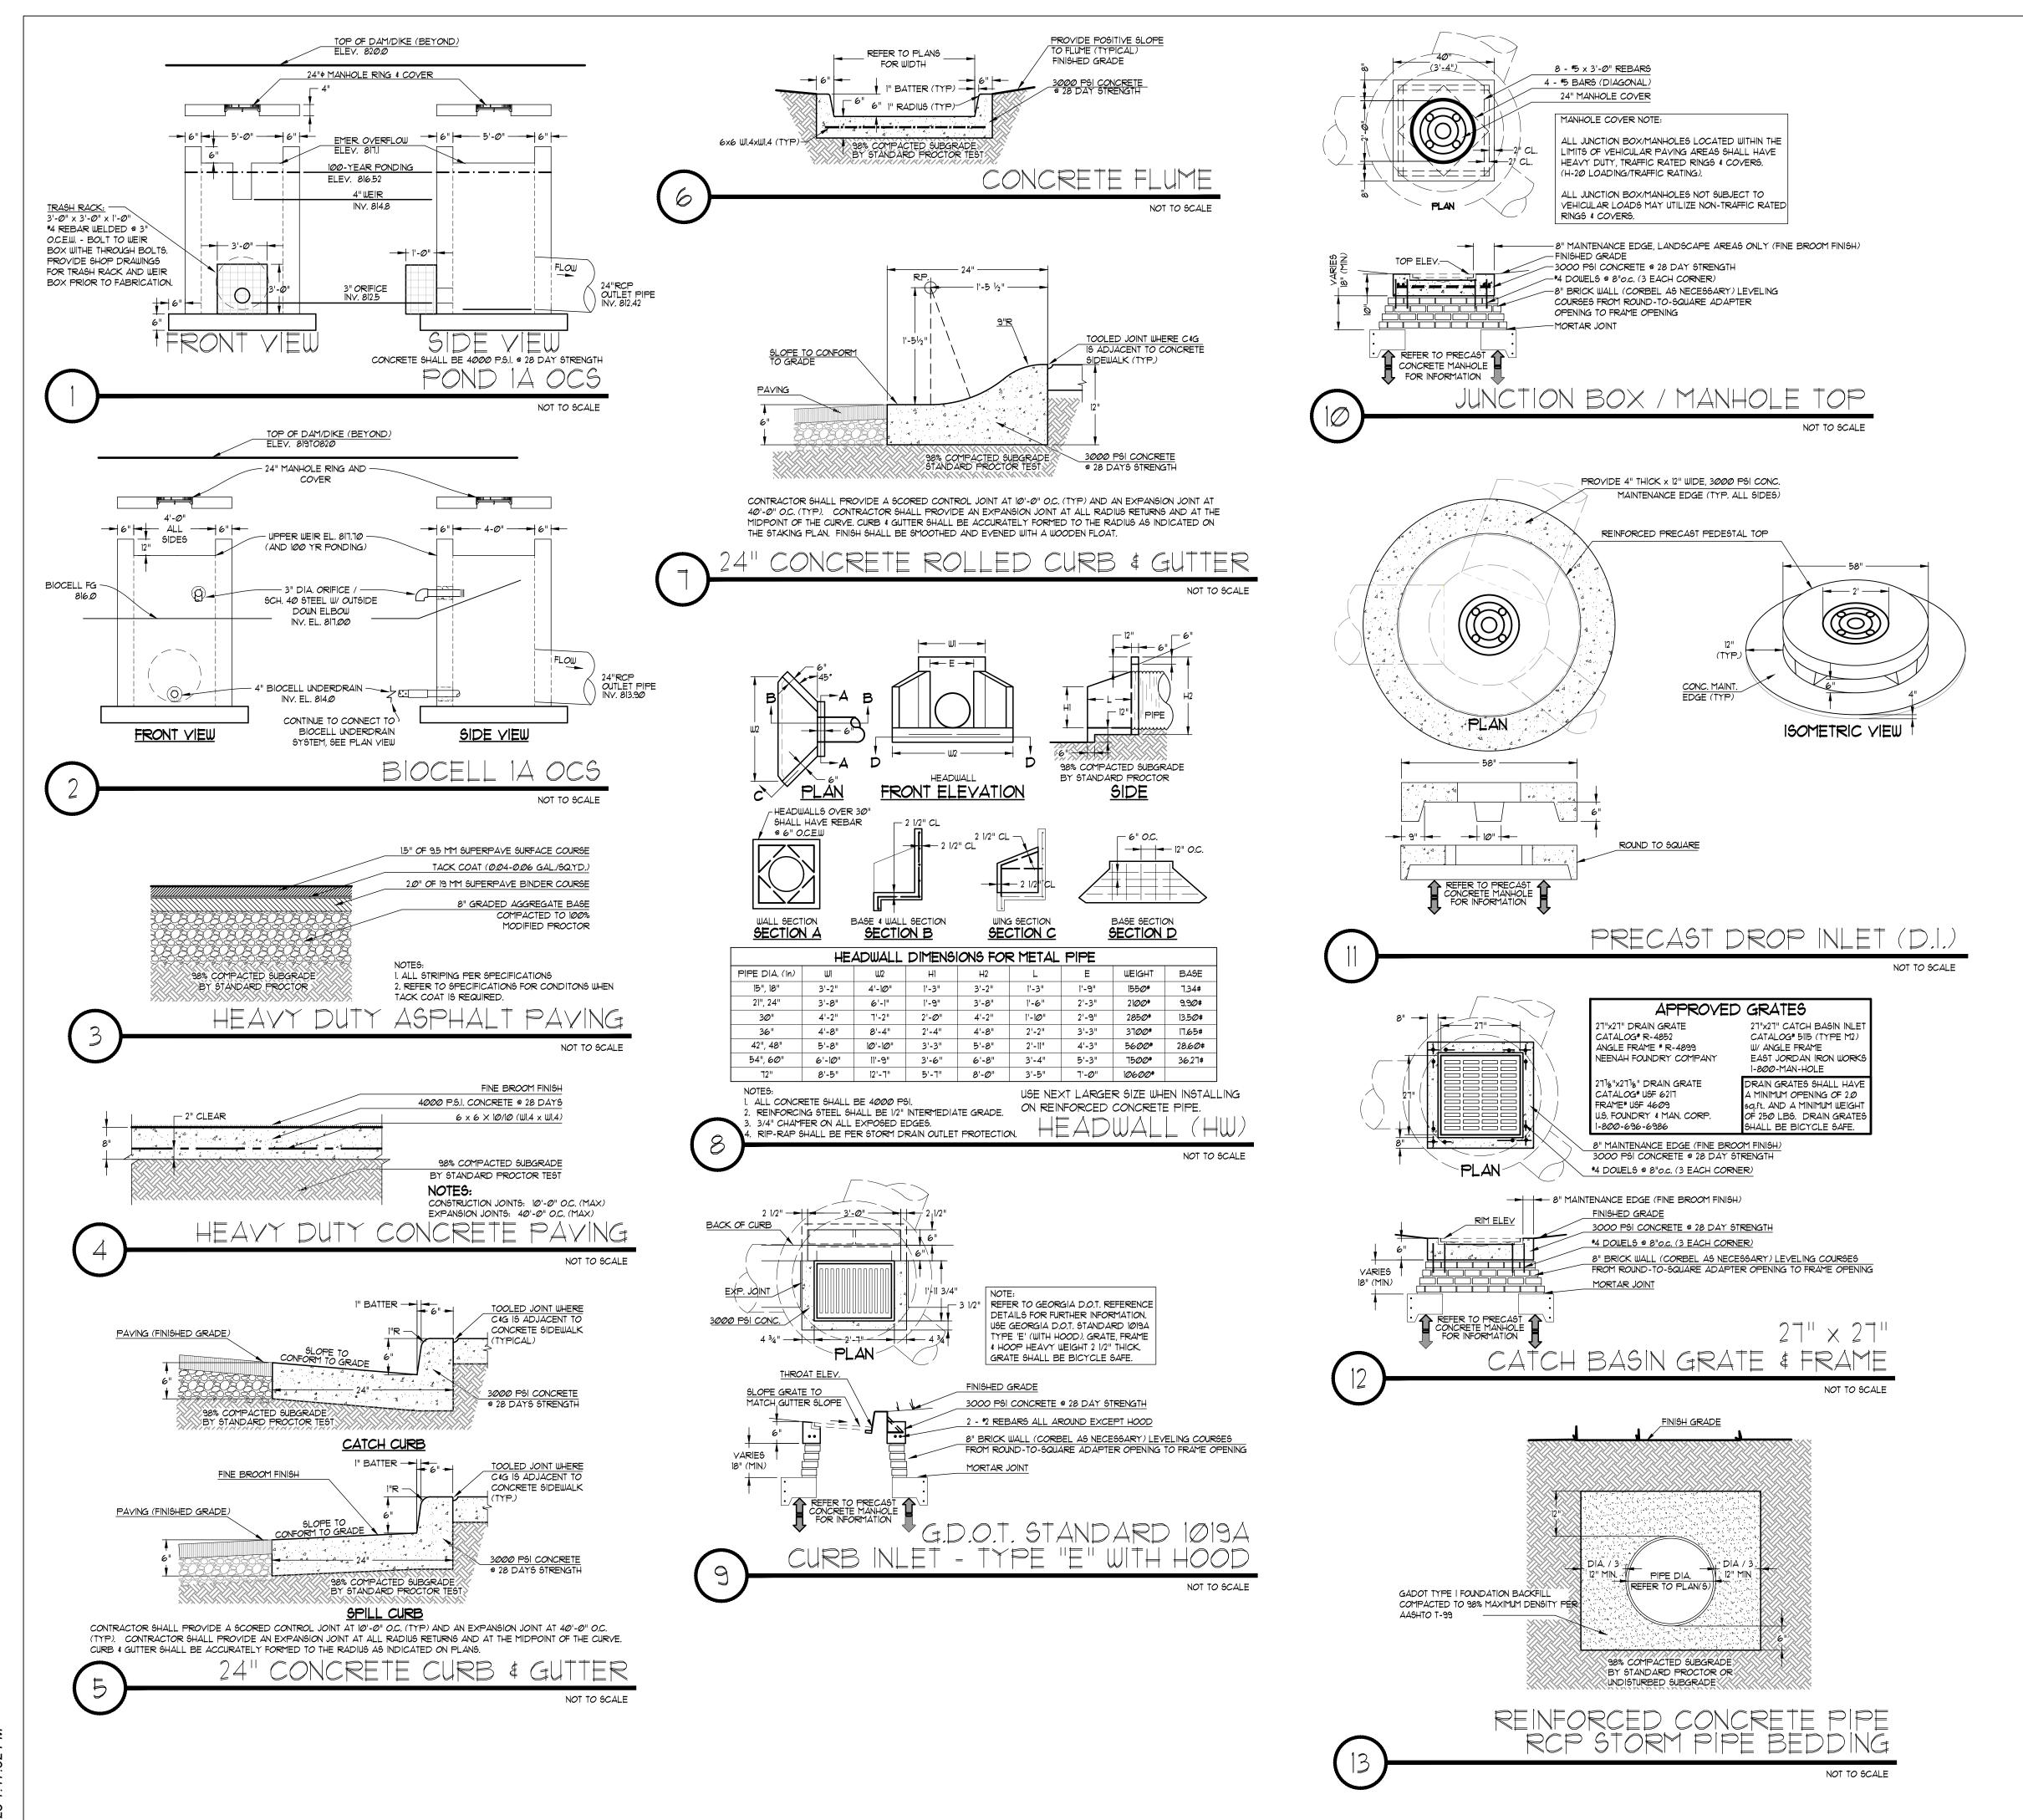



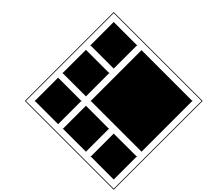

BREEDLOVE LAND PLANNING Landscape Architects ◆ Civil Engineers 15 Simpson Street, NW, Atlanta, GA 30308 P: 770-483-1173 ◆ www.landplanning.net

BLP PROJ. NO. 22158



COUNT: ROCKDALE (TRAIINNG CA

ROCKDALE COUN COMMISSIONERS PRINT RECORD

No.	DATE	DESCRIPTION
1	07/31/2023	LDP SUBMITTAL
2	09/07/2023	LDP RESUBMITTAL
3	10/12/2023	LDP RESUBMITTAL
4	01/16/2024	LDP RESUBMITTAL

Drawn By Checked By Job No.

Sheet Title

SITE WORK CONSTRUCTION **DETAILS**

Sheet No.

NOTES:
BIOCELL SOIL MEDIA

80% COARSE WASHED SAND (0.02" TO 0.04" DIA, PER AASHTO M-6 OR ASTM C-33 CONC. SAND/10% ORGANIC COMPOST

15% ORGANIC COMPOST


5% ONSITE TOPSOIL


DO NOT INSTALL MEDIA UNTIL UPSTREAM AREAS ARE STABILIZED.


MEDIA COMPONENTS SHALL BE BLENDED THOUGHLY AND INSTALLED IN 6" LIFTS WITH A BLOWER OR CONVEYOR BELT TYPE APPLICATION TO MINIMIZE COMPACTION AND ENSURE EVEN DISTRIBUTION. EACH LIFT SHALL BE THROUGHLY WETTED.


IMEDIATELY AFTER INSTALLATION OF MEDIA, PROVIDE TEMPORARY (ANNUAL RYE GRASS) OR PERMANENT GRASSING DEPENDENT ON SEASON.


BIO-RETENTION CELL
NOT TO SCALE

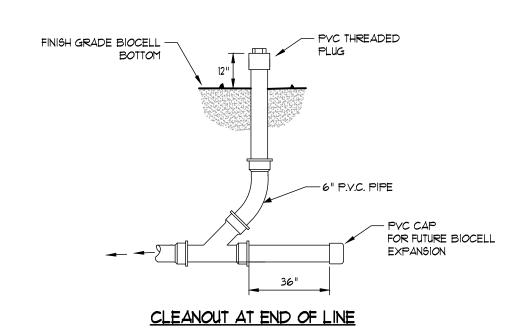


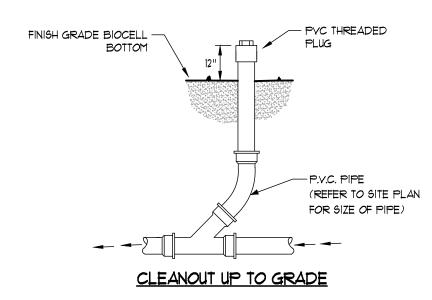

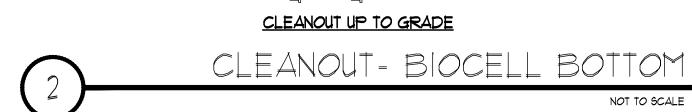

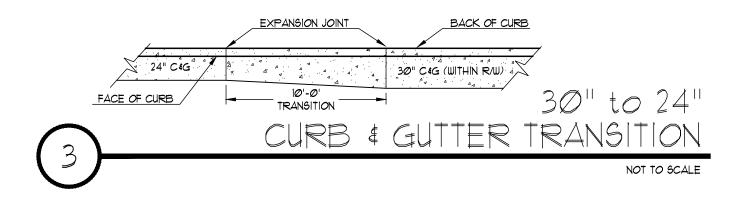

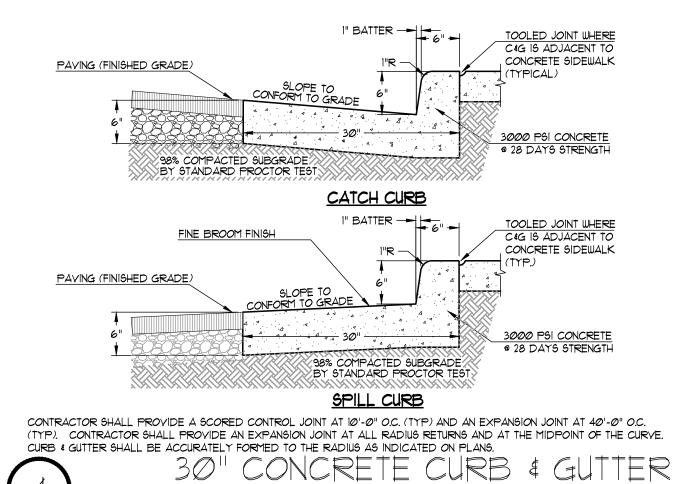


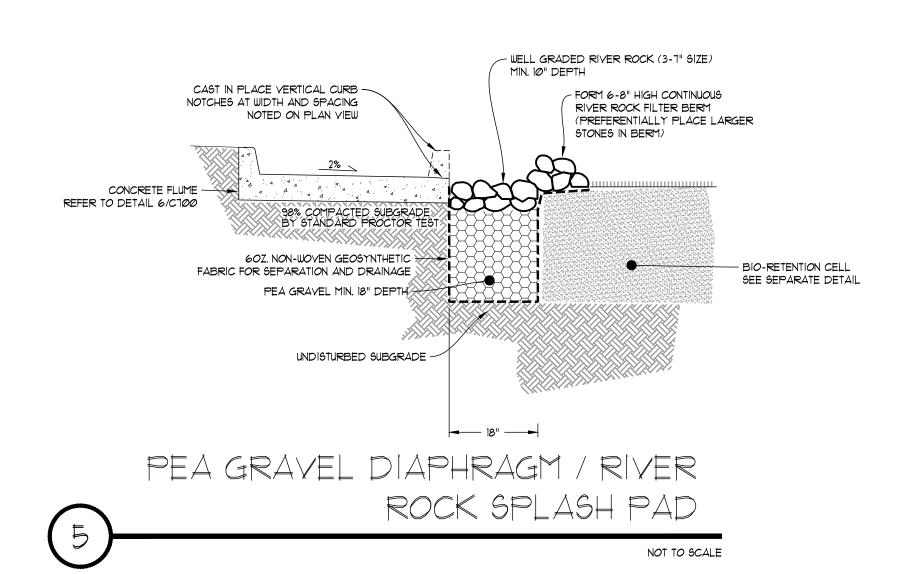

NOT TO SCALE



208 Pirkle Ferry Road, Suite C Cumming, GA 30040

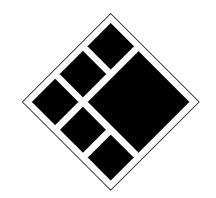

BREEDLOVE LAND PLANNING Landscape Architects ← Civil Engineers
15 Simpson Street, NW, Atlanta, GA 30308
P: 770-483-1173 ← www.landplanning.net

BLP PROJ. NO. 22158



ROCKDALE COUNTY FIRE TRAIINNG CAMPUS

PRINT RECORD

No.	DATE	DESCRIPTION
1	07/31/2023	LDP SUBMITTAL
2	09/07/2023	LDP RESUBMITTAL
3	10/12/2023	LDP RESUBMITTAL
4	01/16/2024	LDP RESUBMITTAL

ROCKDALE COUNT COMMISSIONERS

Drawn By
JRQ

Date

05/05/2023

Checked By
BAM

Job No.
22051

Sheet Title

SITE WORK CONSTRUCTION DETAILS

Sheet No.

C-7.01