**ARCHITECT** 

MEP ENGINEER

CONTRACTOR

# **LOCATION MAP**

Coin Laundry Senior Center

DRAWING TITLE MARK

AXXX/ SCALE

**AXXX**/ (IN PLAN)

**SECTION MARK** 

-DRAWING NUMBER

-SECTION NUMBER

-SHEET REFERENCE

3 WALL SECTION CUT

(IN ELEVATION)

3 DETAIL SECTION CUT

-ELEVATION NUMBER

-SHEET REFERENCE

-SHEET REFERENCE

ELEVATION NUMBER

EXTERIOR ELEVATION MARK

**INTERIOR ELEVATION MARK** 

AXXX

**REVISION TRIANGLE** 

**AREA ON HOLD &** 


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02.23.2024 | Issue for Permit

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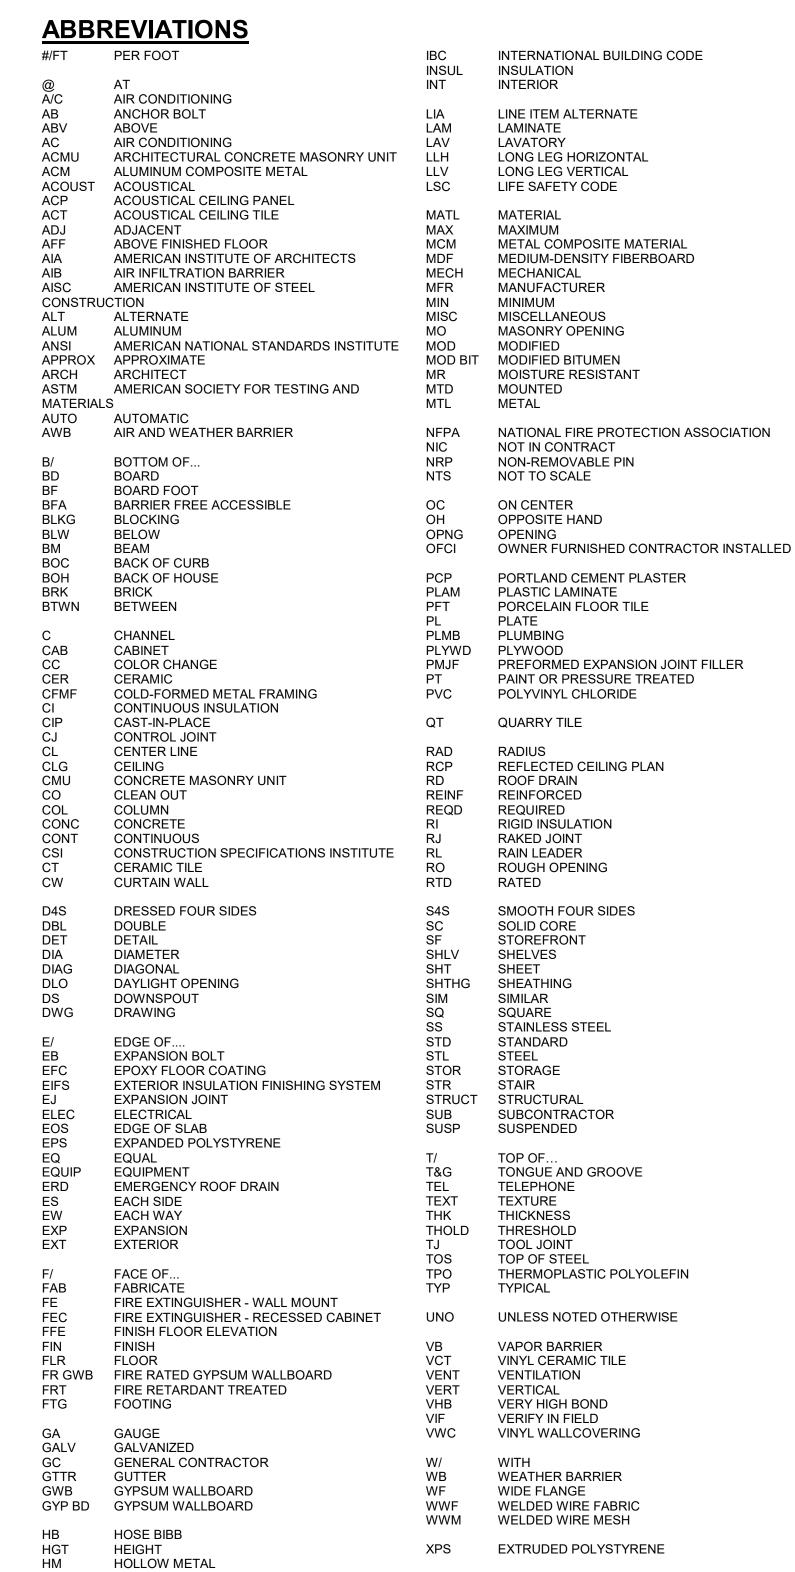
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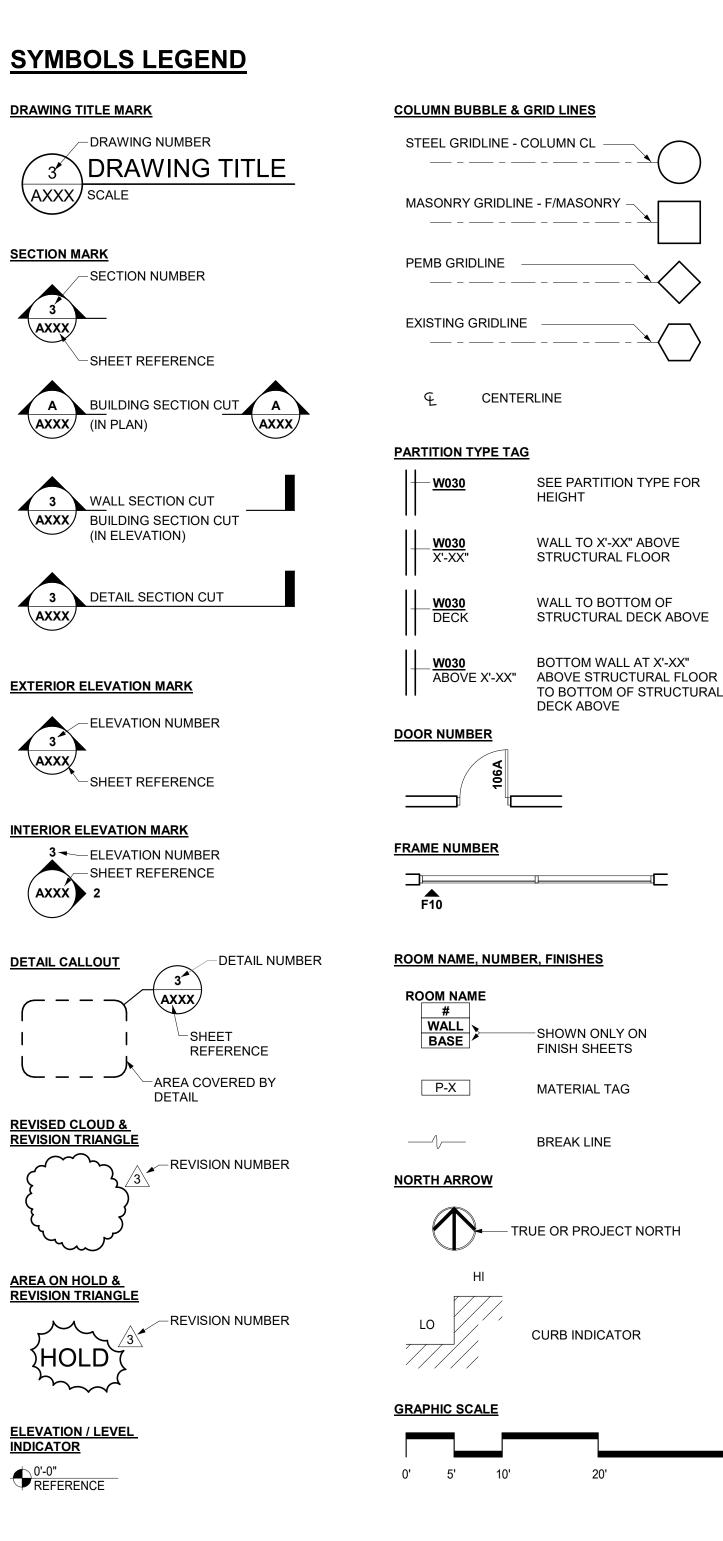
A910

M001

Mechanical

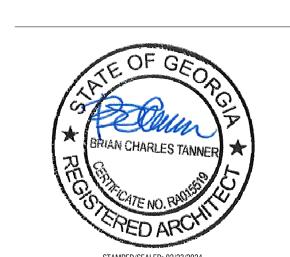

975 SW TAYLOR STREET CONYERS, GA 30012



#### **GENERAL NOTES** THE CONTRACTOR SHALL BE RESPONSIBLE FOR COMPLIANCE WITH THE REQUIREMENTS LISTED IN THE PROJECT MANUAL AND THE DRAWINGS (CONTRACT DOCUMENTS) NCLUDING BUT NOT LIMITED TO THE FOLLOWING:

1. FIELD VERIFY ALL CONDITIONS AND DIMENSIONS PRIOR TO COMMENCING ANY WORK VERIFY EXISTING ELEVATIONS AND LOCATIONS TO BE JOINED PRIOR TO COMMENCING CONSTRUCTION. NOTIFY THE ARCHITECT OF ALL INCONSISTENCIES. DO NOT COMMENCE THE WORK PRIOR TO RECEIPT OF MODIFICATIONS FROM THE ARCHITECT.

2. DO NOT SCALE THE DRAWINGS. IF DIMENSIONS ARE MISSING, NOTIFY THE ARCHITECT. 3. REVIEW AND APPROVE ALL SUBMITTALS BEFORE SUBMITTING TO THE ARCHITECT. THE ARCHITECT SHALL REVIEW SUBMITTALS FOR GENERAL CONFORMANCE WITH THE CONTRACT DOCUMENTS. ARCHITECTS APPROVAL OF SPECIFIC COMPONENTS DOES NOT INDICATE APPROVAL OF THE COMPLETE ASSEMBLY. THE GENERAL CONTRACTOR IS SOLELY RESPONSIBLE FOR CORRECTING ALL NONCOMPLYING WORK INSTALLED WITHOUT ARCHITECT ACCEPTED SUBMITTALS.

4. THE CONTRACTOR IS SOLELY RESPONSIBLE FOR ALL WORK AND MATERIALS INCLUDING THAT OF ALL SUBCONTRACTORS.

5. REPORT TO THE ARCHITECT ALL ERRORS, INCONSISTENCIES OR OMISSIONS FOUND IN CORRECTING ALL ERRORS NOT BROUGHT TO THE ATTENTION OF THE ARCHITECT. CORRECTION OF ERRORS SHALL BE APPROVED BY THE ARCHITECT.

6. LOCATE ALL EXISTING UTILITIES INCLUDING ANY NOT SHOWN IN THE CONTRACT DOCUMENTS. PROTECT ALL EXISTING UTILITIES FROM DAMAGE DURING THE EXECUTION OF THE WORK. THE CONTRACTOR IS SOLELY RESPONSIBLE FOR CORRECTING ANY DAMAGE CAUSED BY OPERATIONS DURING THE EXECUTION OF THE WORK.

7. PROVIDE ALL TEMPORARY SUPPORT FACILITIES INCLUDING BUT NOT LIMITED TO: b. ELECTRICAL POWER

8. THE CONTRACTOR IS SOLELY RESPONSIBLE FOR SAFETY AND SECURITY OF THE SITE UNTIL THE COMPLETION OF PROJECT CLOSEOUT. 9. REMOVE ALL DEBRIS FROM THE SITE DAILY. THE SITE SHALL BE KEPT BROOM CLEAN

10.PERMANENTLY IDENTIFY ALL FIRE AND SMOKE BARRIERS AND PARTITIONS, INCLUDING

a. RATED CORRIDOR WALLS. b. SMOKE BARRIERS AND PARTITIONS.

c. HORIZONTAL EXITS. d. EXIT ENCLOSURES.

c. TOILET FACILITIES.

WITH MINIMUM ONE INCH HIGH LETTERS IN SIGNS OR STENCILING, LOCATED ABOVE CEILING OR OTHER CONCEALED LOCATIONS, SPACED A MAXIMUM OF 10 FEET ON CENTER; PROVIDE THE FOLLOWING CONTENT:

#### "FIRE AND/OR SMOKE RATED WALL-PROTECT ALL OPENINGS"

11.MAINTAIN ALL FIRE AND SMOKE RATINGS SHOWN IN THE CONTRACT DOCUMENTS. PROVIDE A RATED ASSEMBLY, APPROVED BY A NATIONALLY RECOGNIZED TESTING AGENCY, AT ALL OPENINGS AND PENETRATIONS.

12.SWING ALL DOORS IN THE MEANS OF EGRESS IN THE DIRECTION OF EXIT TRAVEL. PROVIDE EMERGENCY HARDWARE ON ALL EXIT ENCLOSURES AND AT ALL EXIT

13.PROVIDE LEVER HANDLE OR PUSH OPERATED HARDWARE ON ALL DOORS NOT IN THE MEANS OF EGRESS. 14.PROVIDE ONE AND ONE HALF INCH TUBES FOR ALL HANDRAILS AND GUARDRAILS

SMALLER TUBE AND PIPE SIZED ARE ALLOWED FOR THE SUPPORT ASSEMBLY IN

COMPLIANCE WITH ALL CODES ADOPTED BY THE JURISDICTION HAVING AUTHORITY 15.DO NOT INTERCONNECT DUCT SYSTEMS WITH OTHER BUILDING EXHAUST SYSTEMS. 16.COMBUSTIBLE INTERIOR TRIM SHALL BE CLASS A, B OR C WITH A FLAME SPREAD RATING OF 200 OR LESS.

17.MAINTAIN AND PROTECT ONE SET OF APPROVED PERMIT DOCUMENT ON SITE AT ALL TIMES. DO NOT ALLOW WORKMEN ACCESS TO THE PERMIT DOCUMENTS.

18.MAINTAIN AND KEEP CURRENT, RECORD DOCUMENTS INCLUDING BUT NOT LIMITED TO THE DRAWINGS AND THE PROJECT MANUAL. POST ALL ADDENDA, CHANGE ORDERS AND MINOR CHANGES IN THE WORK DAILY. CONFIRM ALL CONSTRUCTION DRAWINGS ARE

## **ACCESSIBILITY NOTES**

RETURN TO A LIFTED POSITION.

LOCAL ACCESSIBILITY REGULATIONS TO INCLUDE BUT NOT LIMITED TO THE FOLLOWING:

THE INTERNATIONAL SYMBOL OF ACCESSIBILITY SHALL BE LOCATED ALONGSIDE THE DOOR AT THE LATCH SIDE OF ALL ACCESSIBLE RESTROOM FACILITIES. WATER CLOSETS SHALL BE POSITIONED WITH A WALL OR PARTITION TO THE REAR AND ONE SIDE. THE CENTERLINE OF THE WATER CLOSET SHALL BE 16 INCHES MINIMUM

TO 18 INCHES MAXIMUM FROM THE SIDE WALL OR PARTITION. THE SEAT HEIGHT OF A

WATER CLOSET ABOVE THE FINISH FLOOR SHALL BE 17 INCHES MINIMUM AND 19 INCHES

ACCESSIBLE URINALS SHALL BE THE STALL-TYPE OR THE WALL-HUNG TYPE WITH THE RIM 17 INCHES MAXIMUM ABOVE THE FINISH FLOOR OR GROUND. URINALS SHALL BE 13 1/2 INCHES DEEP MINIMUM MEASURED FROM THE OUTER FACE OF THE URINAL RIM TO THE BACK OF THE FIXTURE. PROVIDE A CLEAR FLOOR SPACE 30" X 48" IN FRONT OF THE ACCESSIBLE URINAL.

MAXIMUM MEASURED TO THE TOP OF THE SEAT. SEATS SHALL NOT BE SPRUNG TO

4. LAVATORIES SHALL BE INSTALLED WITH THE FRONT OF THE HIGHER OF THE RIM OR COUNTER SURFACE 34 INCHES MAXIMUM ABOVE THE FINISH FLOOR WITH A CLEARANCE OF 29" FROM THE FLOOR TO THE BOTTOM OF THE APRON. SPACE UNDER A LAVATORY CONSIDERED KNEE CLEARANCE. KNEE CLEARANCE SHALL EXTEND 25 INCHES MAXIMUM UNDER AN ELEMENT AT 9 INCHES ABOVE THE FINISH FLOOR. THE KNEE CLEARANCE SHALL BE 11 INCHES DEEP MINIMUM AT 9 INCHES ABOVE THE FINISH FLOOR AND 8 INCHES DEEP MINIMUM AT 27 INCHES ABOVE THE FINISH FLOOR. SPACE UNDER A LAVATORY BETWEEN THE FINISH FLOOR OR GROUND AND 9 INCHES ABOVE THE FINISH FLOOR OR GROUND SHALL BE CONSIDERED TOE CLEARANCE. TOE CLEARANCE SHALL EXTEND 25 INCHES MAXIMUM AND 17 INCHES MINIMUM UNDER A LAVATORY. KNEE CLEARANCE SHALL BE 30 INCHES WIDE MINIMUM.

5. WATER SUPPLY AND DRAIN PIPES UNDER LAVATORIES AND SINKS SHALL BE INSULATED OR OTHERWISE CONFIGURED TO PROTECT AGAINST CONTACT. THERE SHALL BE NO SHARP OR ABRASIVE SURFACES UNDER LAVATORIES AND SINKS. E. CONTROLS FOR FAUCETS SHALL BE OPERABLE WITH ONE HAND AND SHALL NOT REQUIRE TIGHT GRASPING, PINCHING, OR TWISTING OF THE WRIST. THE FORCE REQUIRED TO ACTIVATE OPERABLE PARTS SHALL BE 5 POUNDS MAXIMUM. HAND-OPERATED METERING FAUCETS SHALL REMAIN OPEN FOR 10 SECONDS MINIMUM.

. MIRRORS LOCATED ABOVE LAVATORIES OR COUNTERTOPS SHALL BE INSTALLED WITH THE BOTTOM EDGE OF THE REFLECTING SURFACE 40 INCHES MAXIMUM ABOVE THE FINISH FLOOR OR GROUND. MIRRORS NOT LOCATED ABOVE LAVATORIES OR COUNTERTOPS SHALL BE INSTALLED WITH THE BOTTOM EDGE OF THE REFLECTING

8. DOORS SHALL NOT SWING INTO THE CLEAR FLOOR SPACE OR CLEARANCE REQUIRED FOR ANY FIXTURE. DOORS SHALL BE PERMITTED TO SWING INTO THE REQUIRED TURNING

SURFACE 35 INCHES MAXIMUM ABOVE THE FINISH FLOOR OR GROUND.

9. GRAB BARS SHALL BE INSTALLED IN A HORIZONTAL POSITION, 33 INCHES MINIMUM AND 36 INCHES MAXIMUM ABOVE THE FINISH FLOOR MEASURED TO THE TOP OF THE GRIPPING SURFACE. GRAB BARS AND ANY WALL OR OTHER SURFACES ADJACENT TO GRAB BARS SHALL BE FREE OF SHARP OR ABRASIVE ELEMENTS AND SHALL HAVE ROUNDED EDGES. GRAB BARS SHALL NOT ROTATE WITHIN THEIR FITTINGS. ALLOWABLE STRESSES SHALL NOT BE EXCEEDED FOR MATERIALS USED WHEN A VERTICAL OR HORIZONTAL FORCE OF 250 POUNDS IS APPLIED AT ANY POINT ON THE GRAB BAR, FASTENER, MOUNTING DEVICE, OR SUPPORTING STRUCTURE.

10. DRINKING FOUNTAINS SHALL BE PROVIDED WITH SPOUT OUTLETS AT 36 INCHES MAXIMUM ABOVE THE FINISH FLOOR AND 38 INCHES MINIMUM AND 43 INCHES MAXIMUM ABOVE THE FINISH FLOOR OR GROUND. THE SPOUT SHALL BE LOCATED 15 INCHES MINIMUM FROM THE VERTICAL SUPPORT AND 5 INCHES MAXIMUM FROM THE FRONT EDGE OF THE UNIT, INCLUDING BUMPERS. THE SPOUT SHALL PROVIDE A FLOW OF WATER 4 INCHES HIGH MINIMUM AND SHALL BE LOCATED 5 INCHES MAXIMUM FROM THE FRONT OF THE UNIT. THE ANGLE OF THE WATER STREAM SHALL BE MEASURED HORIZONTALLY RELATIVE TO THE FRONT FACE OF THE UNIT, WHERE SPOUTS ARE LOCATED LESS THAN 3 INCHES OF THE FRONT OF THE UNIT, THE ANGLE OF THE WATER STREAM SHALL BE 30 DEGREES MAXIMUM. WHERE SPOUTS ARE LOCATED BETWEEN 3 INCHES AND 5 INCHES MAXIMUM FROM THE FRONT OF THE UNIT, THE ANGLE OF THE WATER STREAM SHALL BE 15 DEGREES MAXIMUM.

11. DOOR CLOSERS SHALL BE ADJUSTED SO THAT FROM AN OPEN POSITION OF 90 DEGREES, THE TIME REQUIRED TO MOVE THE DOOR TO A POSITION OF 12 DEGREES FROM THE LATCH IS 5 SECONDS MINIMUM.

12. FIRE DOORS SHALL HAVE A MINIMUM OPENING FORCE ALLOWABLE BY THE APPROPRIATE ADMINISTRATIVE AUTHORITY. THE FORCE FOR PUSHING OR PULLING OPEN A DOOR OR GATE OTHER THAN FIRE DOORS SHALL BE 5 POUNDS MAXIMUM. THESE FORCES DO NOT APPLY TO THE FORCE REQUIRED TO RETRACT LATCH BOLTS OR DISENGAGE OTHER DEVICES THAT HOLD THE DOOR OR GATE IN A CLOSED POSITION.

13. FIRE ALARM SYSTEMS SHALL HAVE PERMANENTLY INSTALLED AUDIBLE AND VISIBLE ALARMS COMPLYING WITH NFPA 72 AND ANSI A117.1. EXCEPT THAT THE MAXIMUM ALLOWABLE SOUND LEVEL OF AUDIBLE NOTIFICATION APPLIANCES COMPLYING WITH SECTION 4-3.2.1 OF NFPA 72 (1999 EDITION) SHALL HAVE A SOUND LEVEL NO MORE THAN 110 DB AT THE MINIMUM HEARING DISTANCE FROM THE AUDIBLE APPLIANCE.

CHANGES IN LEVEL OF 1/4 INCH HIGH MAXIMUM SHALL BE PERMITTED TO BE VERTICAL. CHANGES IN LEVEL BETWEEN 1/4 INCH HIGH MINIMUM AND 1/2 INCH HIGH MAXIMUM SHALL BE BEVELED WITH A SLOPE NOT STEEPER THAN 1:2.

15. FLOOR OR GROUND SURFACE WITHIN REQUIRED MANEUVERING CLEARANCES AT DOORS SHALL COMPLY WITH 15. CHANGES IN LEVEL ARE NOT PERMITTED. EXCEPTIONS:

14. FLOOR AND GROUND SURFACES SHALL BE STABLE, FIRM, AND SLIP RESISTANT.

1. SLOPES NOT STEEPER THAN 1:48 SHALL BE PERMITTED. 2. CHANGES IN LEVEL AT THRESHOLDS COMPLYING WITH 16 SHALL BE PERMITTED.

16. THRESHOLDS, IF PROVIDED AT DOORWAYS, SHALL BE 1/2 INCH HIGH MAXIMUM.

PROPOSED INTERIOR RENOVATIONS TO AN EXISTING SINGLE-STORY SPRINKLERED TYPE V-B OCCUPANCY BUILDING. THE BUILDING HAS AN APPROXIMATE GROSS AREA OF 14000 SF AND

THE AREA OF WORK CONSISTS OF THE FULL FLOOR PLATE. RENOVATIONS TO THE AREA OF

PLUMBING FIXTURES, PLUMBING LOCATIONS, AND DOORS. NEW CONSTRUCTION INCLUDES

BUILD OUT OF NEW INTERIOR PARTITIONS, CEILINGS, LIGHTING, NEW MILLWORK, PLUMBING

WORK INCLUDE DEMOLITION OF SELECT INTERIOR PARTITIONS, CEILINGS, LIGHTING,

LOCATIONS, REUSE OF PLUMBING FIXTURES, AND UPDATE OF INTERIOR FINISHES.

Project Number: 23122 Project Name:

# **DHS ROCKDALE**

975 SW Taylor Street, Conyers, GA

Key Plan:

Sheet Title:

Cover, Project Direct., Sheet Index

Sheet Number:

G001

# DHS ROCKDALE COUNTY

HORIZONTAL

HOLLOW STRUCTURAL SECTION

PROJECT DESCRIPTION

#### Department of Human Services - Division of Family and Children Services, Rockdale County

**Applicable Codes** 

International Building Code (IBC) 2018 Edition with State of Georgia Amendments International Fire Code (IFC) 2018 Edition with State of Georgia Amendments

Internation Plumbing Code (IPC) 2018 Edition with State of Georgia Amendments International Mechanical Code (IMC) 2018 Edition with State of Georgia Amendments International Fuel Gas Code 2018 Edition with State of Georgia Amendments

National Electrical Code (NEC) 2018 Edition with State of Georgia Amendments International Energy Conservation Code (IECC) 2018 Edition with State of Georgia Amendments

Internation Existing Building Code 2018 Edition

NFPA 101 Life Safety Code (LSC) with Georgia Amendments

Class "C" roof assembly req'd

ADA Standards for Accessible Design 2010 Edition

Occupancy Types: B - Business

Building Description: Proposed interior renovations to an existing single-story, sprinklered Type V-B occupancy building. The building has an approximate gross area of 14000 SF and the Area of Work consists of the full floor plate. Renovations to the Area of Work include demolition of select interior partitions, doors, ceilings, lighting, plumbing fixtures, plumbing locations, and doors. New construction includes build out of new interior partitions, ceilings, lighting, new millwork, plumbing locations, reuse of plumbing fixtures, and update of interior finishes.

Construction Type V-B (Existing)	(Sprinklered)  Type V-B  Sprinklered
Req'd fire resistance per IBC Table 601, 602	
Primary structural frame	0
Bearing Walls	
Exterior: Fire separation Distance > 30'	0
Interior:	0
Nonbearing walls - Exterior	0
Nonbearing walls - Interior	0
Floor construction and associated secondary members	0
Roof construction and associated secondary members	0
Min roof slope = 1/4" per foot	

Allowable Height and Area Type V-B, Spi			
Allowable building height and story (IBC Tables 504.3 & 504.4)		60'/3 stories	
Allowable building area (IBC Table 506.2)		36,000	
Area Increase from Frontage Increase (IBC 506.3 and Equation 5-5) If =.54	4,860		
Increased Allowable story area (IBC 506.2.4 and Equation 5-1)	40,860		

#### Occupant Load Calculations Per NFPA SF Use Occ/SF 2,058 Business 150 1,573 Assembly Lobby, Assembly Conference 733 Assembly 386 Assembly Conference 1,023 Storage Total Square Footage **Total Occupants**


Means of Egress Capacity (from NFPA 101 Table A.7.6)					
Max. Travel Distance	300'				
Max. Common Path of Travel	30'				
Max. Dead End Corridor	20'				
No. of Exits Required per Story	2				
Corridor Minimum Width	44"				
Egress Width Required per NFPA 7.2.1.2.3.2					
	Factor	Required	Provided		
Door Widths	0.2	34	170	(68" at 6' door)	

#### Plumbing Fixture Counts

Reference: Florida Building Code - Plumbing, Seventh Edition, Table 403.1 Business Total Occupants - (B) Water Closets: 1 per 25 for first 50 and 1 per 50 for remainder Urinals: \*Urinals cannot substitute > 50% of required WC's Lavatories: 1 per 40 for first 80 and 1 per 80 for remainder Drinking Fountain: 1 per 100

	В	
	Required	Provided
W/C - Female	3.0	3.0
W/C - Male	3.0	2.0
W/C - Unisex	-	2.0
Lav - Female	3.0	2.0
Lav - Male	3.0	1.0
Lav - Unisex	-	2.0
Drinking Fountains	2.0	2.0

#### **OCCUPANCY & EGRESS LEGEND**

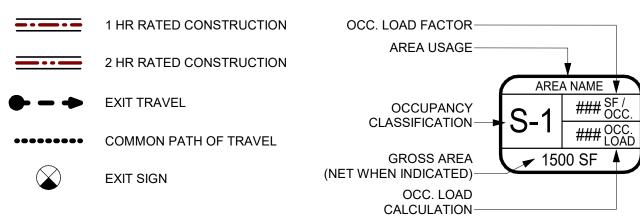

NOTE: SURVEY TO BE CONDUCTED TO LOCATE EXISTING EXIT SIGNS. EXISTING EXIT SIGNS TO REMAIN. NEW EXIT SIGN TO BE PLACE WHERE INDICATED ON PLAN, WITHOUT AN EXISTING EXIT SIGN.

- **▼**—EGRESS DIRECTION ARROW
- FIRE EXTINGUISHER BRACKET MOUNTED
- SEMI-RECESSED FIRE **EXTINGUISHER CABINET**

**≠** 1500 SF 🕴

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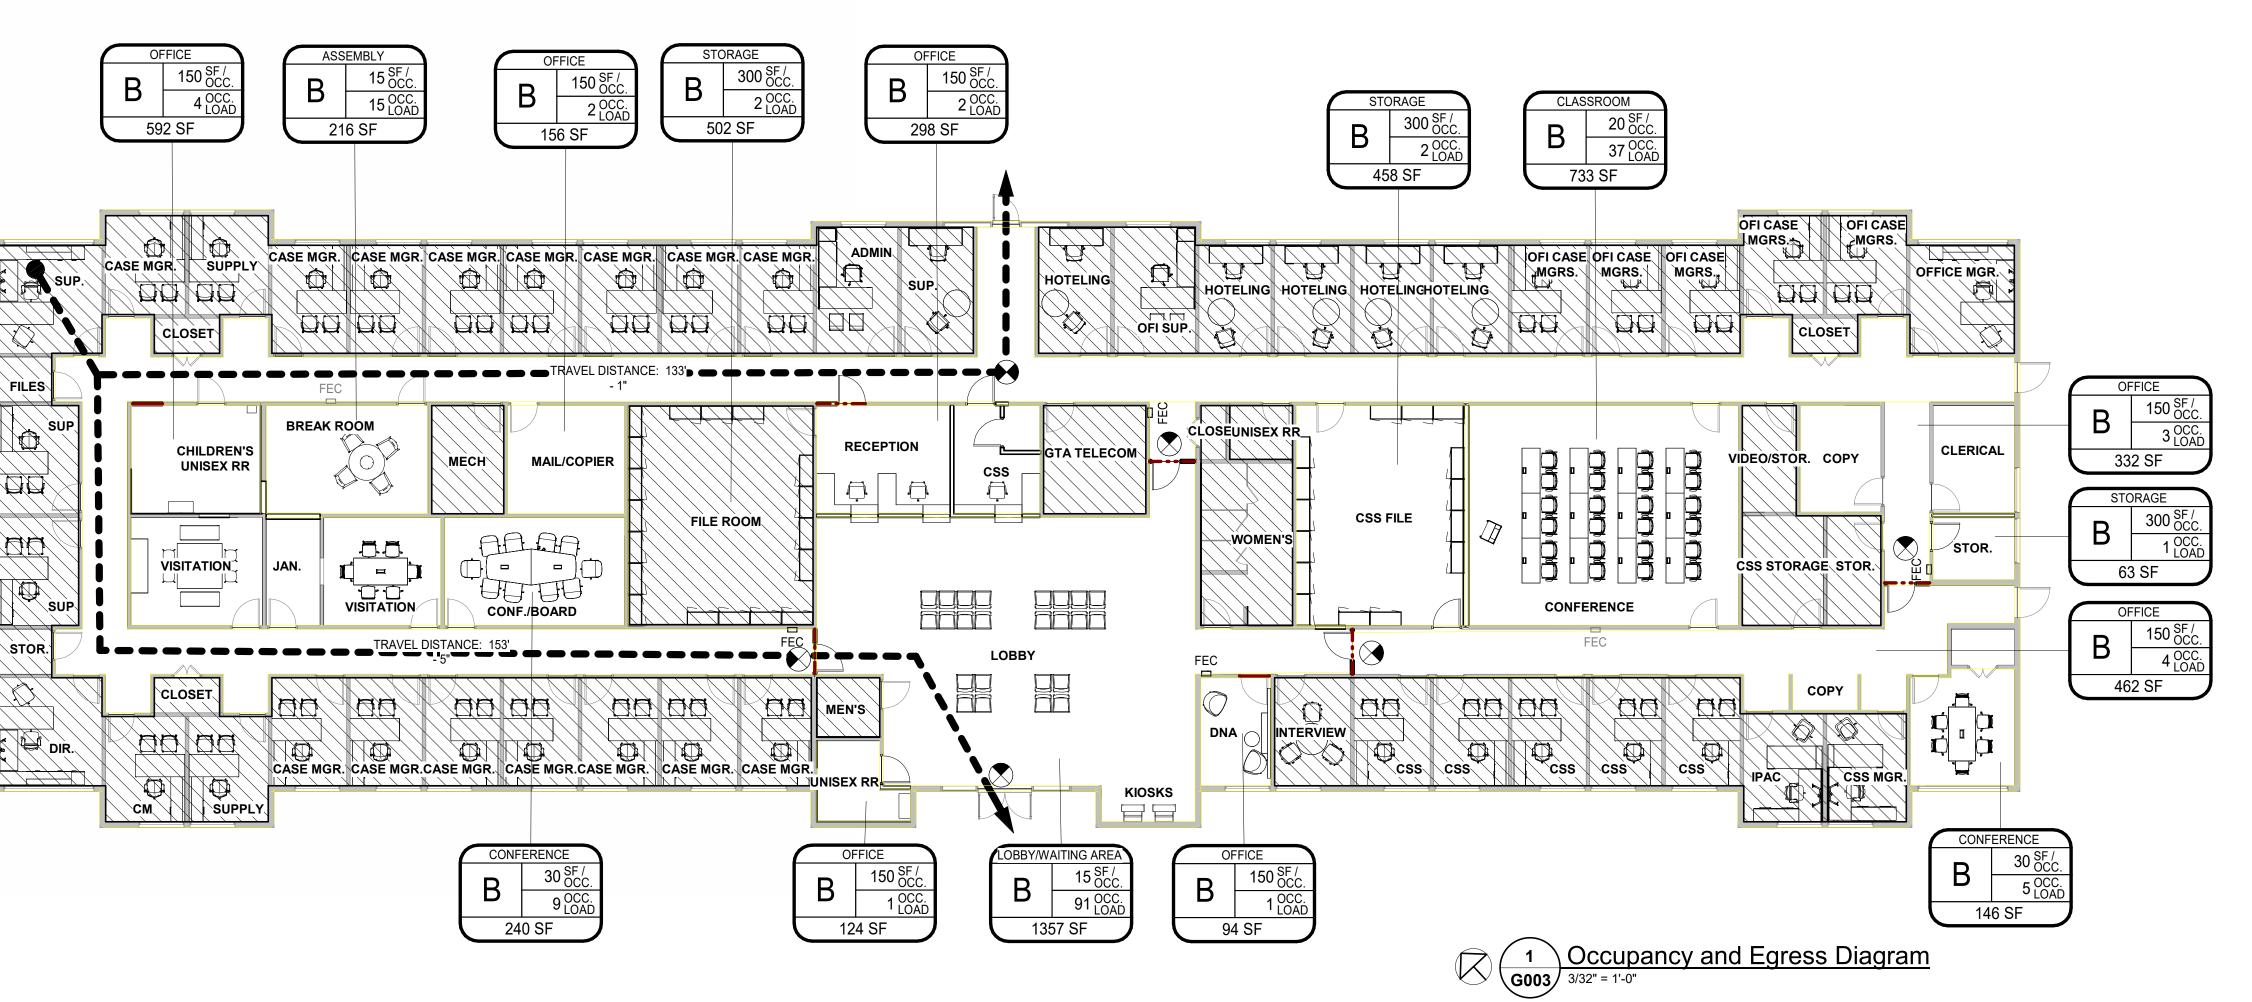
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Rev Date Comments

Occupancy Types Legend



**DEPARTMENT OF HUMAN SERVICES** 

Project Number: 23122

Project Name: DHS ROCKDALE COUNTY

975 SW Taylor Street, Conyers, GA

Code **Information** -

**Occupancy** Sheet Number:

G003

#### **DEMOLITION KEYNOTES**

- D01 REMOVE EXISTING DOOR, FRAME AND HARDWARE. PATCH AND REPAIR FLOORING, AS NEEDED. REINSTALL EXISTING DOORS IN NEW DOOR LOCATIONS WHERE POSSIBLE.
- D02 REMOVE EXISTING PLUMBING FIXTURES, CAP THE PIPES. REINSTALL WHERE APPLICABLE IN RESTROOMS OR JANITOR CLOSET. D03 REMOVE AND SLAVAGE EXISTING MILLWORK. PATCH AND
- REPAIR WALL AND FLOORING, AS NEEDED. D04 REMOVE EXISTING EQUIPMENT. REMOVE AND REINSTALL IN NEW COPY AREA.
- D06 REMOVE EXISTING WALL. PATCH AND REPAIR FLOORING, AS NEEDED.

D09 REMOVE AND SALVAGE EXISTING OPERABLE PARTITION.

- D07 REMOVE EXISTING DOOR, FRAME AND HARDWARE. REINSTALL WITH DOOR SWING FLIPPED.
- D08 REMOVE EXISTING MILLWORK, AS NEEDED, FOR NEW PARTITION PLACEMENT. PROTECT AND REINSTALL MILLWORK IN EXISTING LOCATION, ONCE PARTITION CONSTRUCTION IS COMPLETE.

#### **GENERAL DEMOLITION NOTES** THE GENERAL CONTRACTOR SHALL BE RESPONSIBLE FOR COMPLIANCE WITH THE REQUIREMENTS LISTED IN

## THE PROJECT MANUAL AND THE DRAWINGS (CONTRACT DOCUMENTS) INCLUDING BUT NOT LIMITED TO THE

1. THE DEMOLITION DRAWINGS, INCLUDING BUT NOT LIMITED TO THE CIVIL, ARCHITECTURAL, STRUCTURAL, MECHANICAL, PLUMBING, ELECTRICAL, AND FIRE PROTECTION DRAWINGS, DEFINE THE GENERAL SCOPE OF THE DEMOLITION REQUIRED. THE DEMOLITION DRAWINGS ARE NOT A COMPLETE LIST OF ALL ITEMS TO BE DEMOLISHED. THE DEMOLITION DRAWINGS DO NOT INCLUDED ALL EXISTING CONDITIONS. THE CONTRACTOR WILL VISIT THE SITE AND THOROUGHLY EVALUATE AND COMPARE THE DEMOLITION DRAWINGS, EXISTING SITE CONDITIONS AND THE CONTRACT DOCUMENTS TO DETERMINE THE SCOPE OF DEMOLITION REQUIRED TO ACHIEVE THE INTENDED RESULTS OF THE FINISHED PRODUCT.


2. ALL DEMOLITION WORK SHALL BE PERFORMED WITH DUE CARE AND DILIGENCE TO PREVENT DESTRUCTION OR INTERRUPTION OF CONCEALED SERVICE UTILITIES WHICH ARE INTENDED TO REMAIN IN USE.

3. ALL COMPONENTS OF THE EXISTING CONSTRUCTION THAT WOULD INTERFERE WITH THE INSTALLATION OF NEW WORK SHOWN IN THE CONTRACT DOCUMENTS SHALL BE DEMOLISHED.

- 4. DEMOLITION TERMS A. REMOVE: LEGALLY DISPOSE OF ITEMS EXCEPT THOSE INDICATED TO BE REINSTALLED, SALVAGED OR TO REMAIN THE OWNER'S PROPERTY.
- B. SALVAGE: ITEMS INDICATED TO BE REMOVED AND SALVAGED, REMAIN THE OWNER'S PROPERTY. REMOVE, CLEAN AND PACK OR CRATE ITEMS TO PROTECT AGAINST DAMAGE. IDENTIFY CONTENTS OF CONTAINERS AND DELIVER TO OWNER'S DESIGNATED STORAGE AREA. C. REMOVE AND REINSTALL: ITEMS INDICATED TO BE REMOVED AND REINSTALLED SHALL BE
- REMOVED, CLEANED, REPAIRED /RESTORED AND STORED AT THE CONTRACTOR'S DESIGNATED STORAGE AREA FOR INSTALLATION AS INDICATED ON THE DRAWINGS.
- D. EXISTING TO REMAIN: PROTECT CONSTRUCTION INDICATED TO REMAIN AGAINST DAMAGE AND SOILING DURING DEMOLITION. WHEN PERMITTED BY THE ARCHITECT, ITEMS MAY BE REMOVED TO A SUITABLE, PROTECTED STORAGE LOCATION DURING DEMOLITION AND THEN CLEANED AND REINSTALLED IN THEIR ORIGINAL LOCATIONS.

A. PROVIDE DEMOLITION TO THE EXTENT REQUIRED TO ACHIEVE NEW LAYOUT AS SHOWN. GENERAL CONTRACTOR IS RESPONSIBLE FOR THE PROPER PROTECTION OF ALL EXISTING ITEMS TO REMAIN. THE GENERAL CONTRACTOR IS TO REPAIR AND/OR REPLACE ANY DAMAGE TO EXISTING ITEMS TO REMAIN OR

- SURROUNDING AREAS AS REQUIRED.
- B. GENERAL CONTRACTOR TO REMOVE AND CAP ALL UTILITIES TO SITE SOURCE. REMOVE ALL ABANDONED CABLES, WIRES, AND PIPES IN CEILING PLENUM AND ELSEWHERE TO THEIR SOURCE. REMOVE ALL ABANDONED TELEPHONE EQUIPMENT. REMOVE ANY SPEAKERS, VISUAL AID FIXTURES, AND CONTROL DEVICES UNLESS OTHERWISE INDICATED OR LOCATED ON BUILDING CORE. ANY REMOVAL OF SUCH EQUIPMENT SHALL BE DONE IN SUCH A WAY AS TO ALLOW THE OPERATIONS OF ADJACENT FLOORS OR TENANTS TO CONTINUE WITHOUT INTERRUPTION OF SERVICES.
- C. DEMOLITION WORK THAT CREATES DISTURBING NOISE MUST BE COORDINATED AND SCHEDULED WITH BUILDING OWNER/MANAGEMENT AND PERFORMED DURING OFF-HOURS AS REQUIRED. ANY OVERTIME COSTS FOR THESE ITEMS ARE TO BE BORNE BY THE GENERAL CONTRACTOR.
- D. GENERAL CONTRACTOR TO REMOVE ALL ABANDONED TEL/DATA AND ELECTRICAL DEVICES IN PARTITIONS EXCEPTING THOSE THAT ARE SHOWN FOR REUSE ON THE DRAWINGS. PATCH AND REPAIR PARTITION
- SURFACES AS REQUIRED SO THAT NO VISIBLE ASPECTS OF THE DEVICE REMAIN. E. GENERAL CONTRACTOR IS TO RAISE AND PROTECT BLINDS AS REQUIRED DURING DEMOLITION AND NEW CONSTRUCTION. ALL BLINDS ARE TO BE CLEANED AT THE CONCLUSION OF THE WORK.

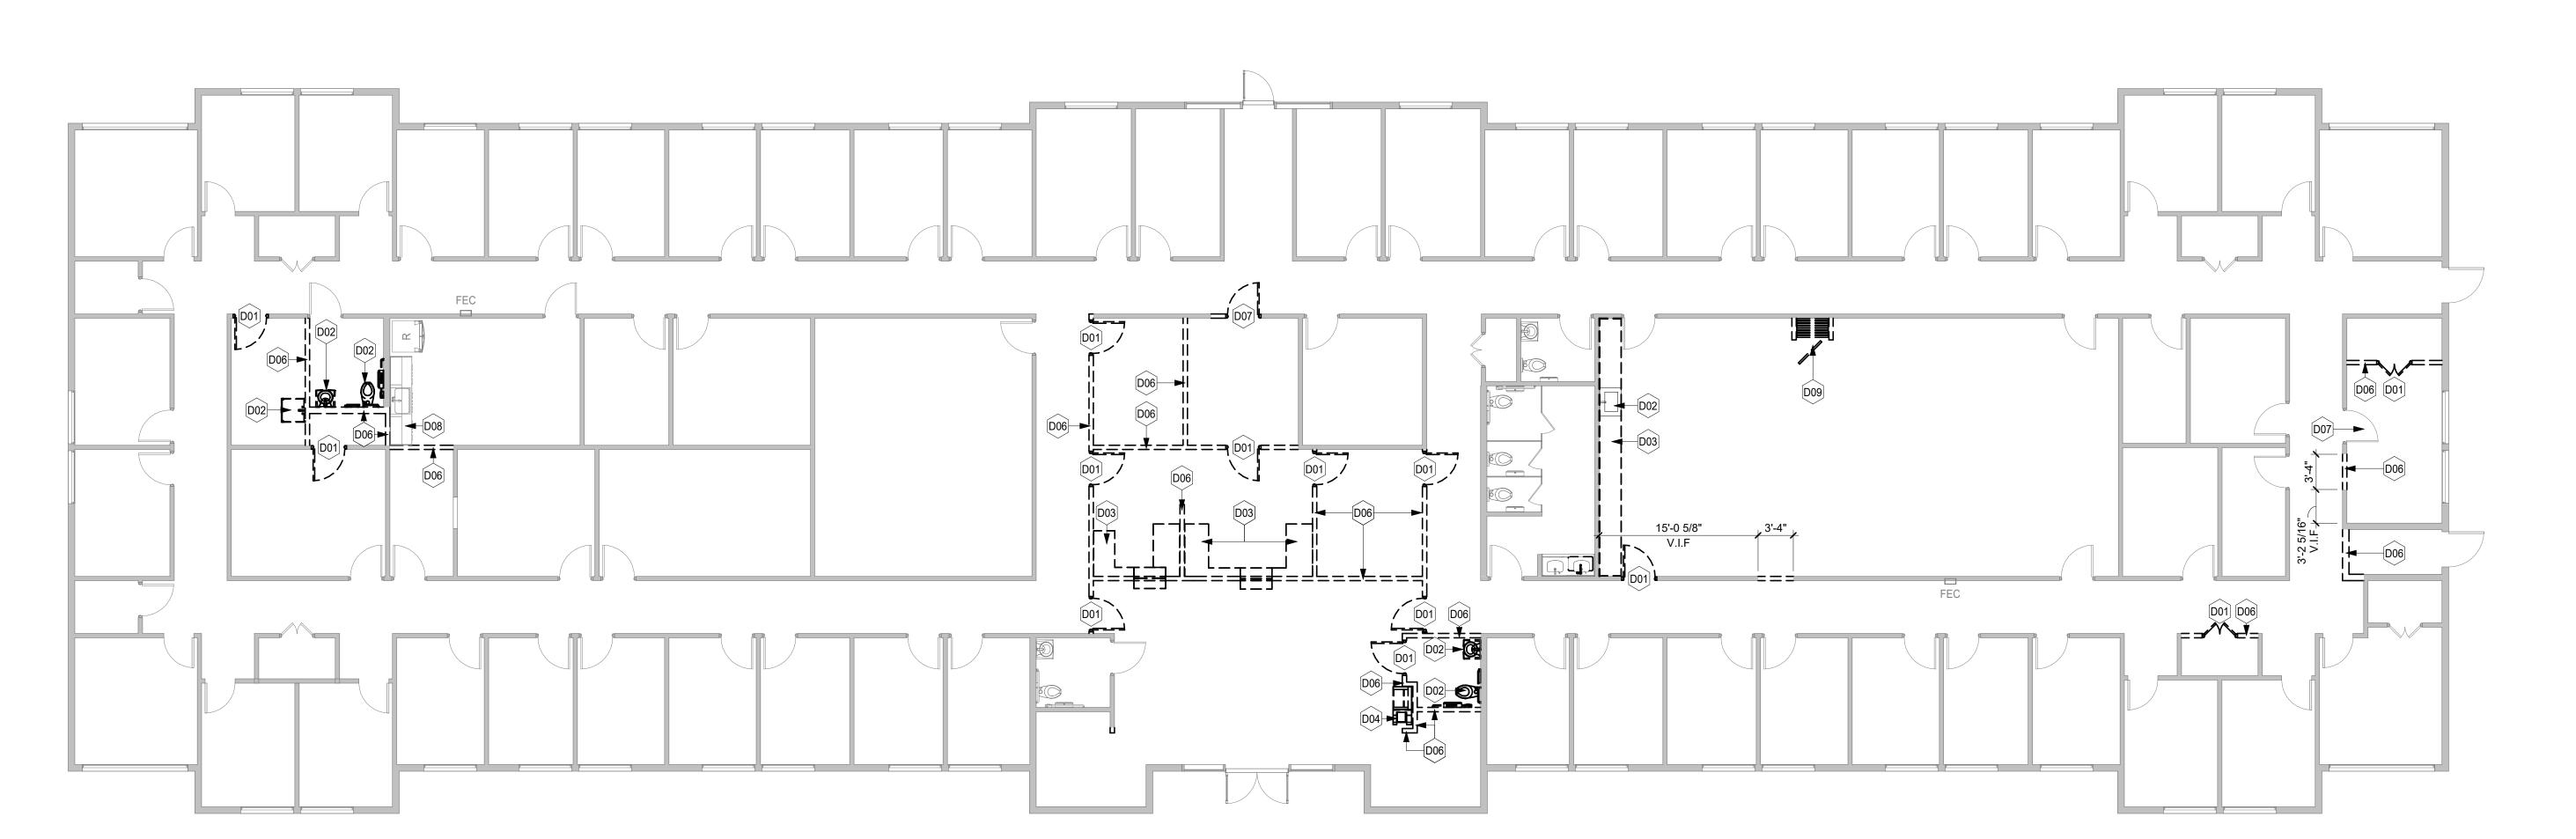



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**DEPARTMENT OF HUMAN SERVICES** 

Project Number: 23122 Project Name:

DHS ROCKDALE **COUNTY** 

975 SW Taylor Street, Conyers, GA 30012

Key Plan:

Floor Plan -**Demolition** 

**AD200** 

### **GENERAL CONSTRUCTION NOTES**


- 1. ALL EXISTING PARTITIONS TO REMAIN ARE TO BE RESTORED TO FINISHED CONDITION AS REQUIRED TO RECEIVE NEW FINISHES. REMOVE ALL UNUSED WALL-MOUNTED ITEMS, PROTRUSIONS,OR EQUIPMENT.
- 2. THE FOLLOWING SPACES ARE TO HAVE FULL HEIGHT PARTITIONS TO DECK WITH SOUND ATTENUATION BATTS: CONFERENCE ROOMS AND RESTROOMS. IF THE STRUCTURE IS GREATER THAN 15 FT., IT IS ACCEPTABLE TO EXTEND PARTITIONS TO 12" ABOVE CEILING AND APPLY SOUND BATTS ABOVE CEILING FOR 2 FT. ON EITHER SIDE OF THE PARTITION.
- 3. GENERAL CONTRACTOR TO PROVIDE FIRE-RETARDANT WOOD BLOCKING OR METAL ANGLES WITHIN PARTITIONS WHERE ALL CABINETS, COUNTERS, MILLWORK, AND WALL-MOUNTED TELEVISIONS
- ARE TO BE MOUNTED. 4. WITHIN BUILDINGS WITH NO SPRINKLER SYSTEM, ALL FILE ROOMS AND STORAGE ROOMS OVER 100 S.F. ARE TO BE 1-HOUR FIRE RATED. 5. IF SO INDICATED ON THE DRAWINGS, PROVIDE FOLDING PARTITION SYSTEM, PANELFOLD "MODUFLEX" MODEL 420 WITH AN STC RATING OF 50 OR GREATER, OR SIMILAR PRODUCT APPROVED EQUAL IN QUALITY AND PERFORMANCE. GENERAL CONTRACTORTO PROVIDE ALL STRUCTURAL BRACING AND REINFORCEMENT NECESSARY FOR A

COMPLETE AND FUNCTIONAL INSTALLATION. PANEL FINISH TO BE VINYL

SELECTED FROM MANUFACTURER'S STANDARD FINISH SELECTIONS.

#### **Interior Partition Notes**

- 1. NOTIFY ARCHITECT IF ANY ABOVE CEILING ANGLED BRACING LENGTH EXCEEDS 12'-0"
- 2. METAL STUD PARTITIONS ARE NOT TO EXCEED A MAXIMUM MID-SPAN DEFLECTION OF L/240

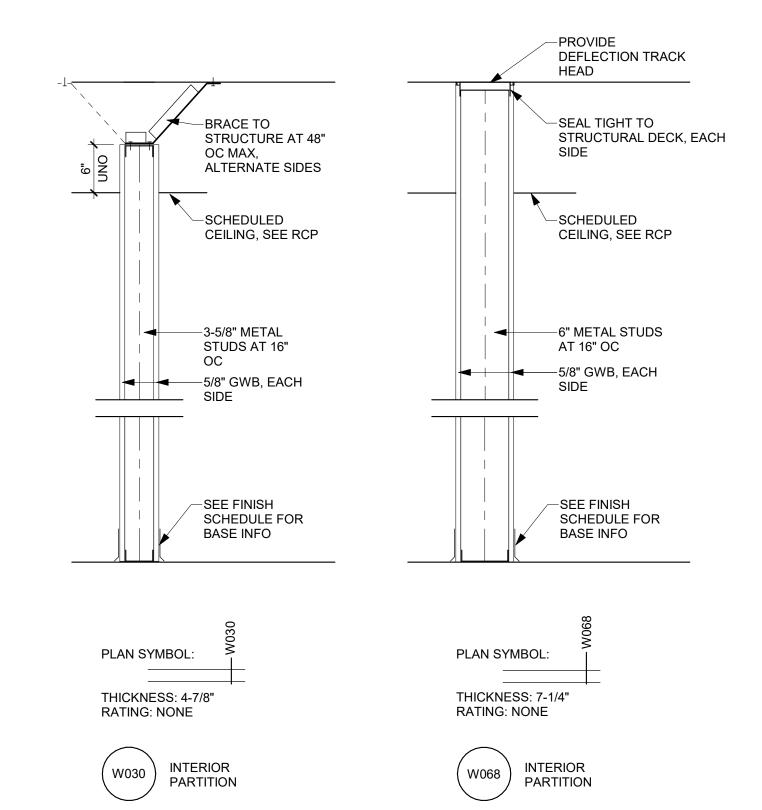

# **PARTITION LEGEND**

**GRID LEGEND** 

PEMB GRIDLINE -

EXISTING GRIDLINE—

STEEL GRIDLINE - COLUMN CL -

\_\_\_\_\_\_


MASONRY GRIDLINE - F/MASONRY -

GWB & STUD PARTITION = = DEMOLISHED PARTITION EXISTING PARTITION AREA NOT IN SCOPE

## **SOUND ATTENUATION KEYNOTES**

ALL STUD WALLS SURROUNDING AND WITHIN THE ROOM ARE TO RECEIVE SOUND ATTENUATION INSULATION THE FULL DEPTH AND HEIGHT OF THE STUD CAVITY. SEAL ALL WALL PENETRATIONS.



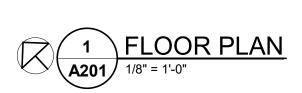

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**DEPARTMENT OF HUMAN SERVICES** 


Project Number: 23122 Project Name:

DHS ROCKDALE COUNTY

975 SW Taylor Street, Conyers, GA

Key Plan:

Sheet Title:
Floor Plan

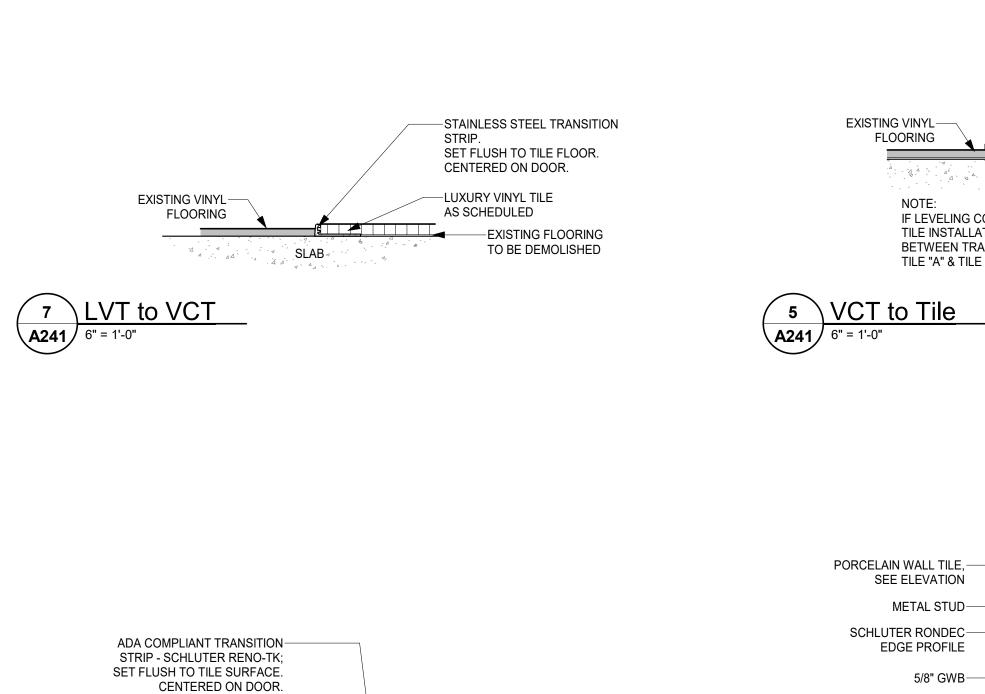


—EXISTING VINYL FLOORING


PROVIDE LEVELING COMPOUND AS REQ'D FOR FLUSH TRANSITION

CARPET AS SCHEDULED-

EXISTING FLOORING -

TO BE DEMOLISHED

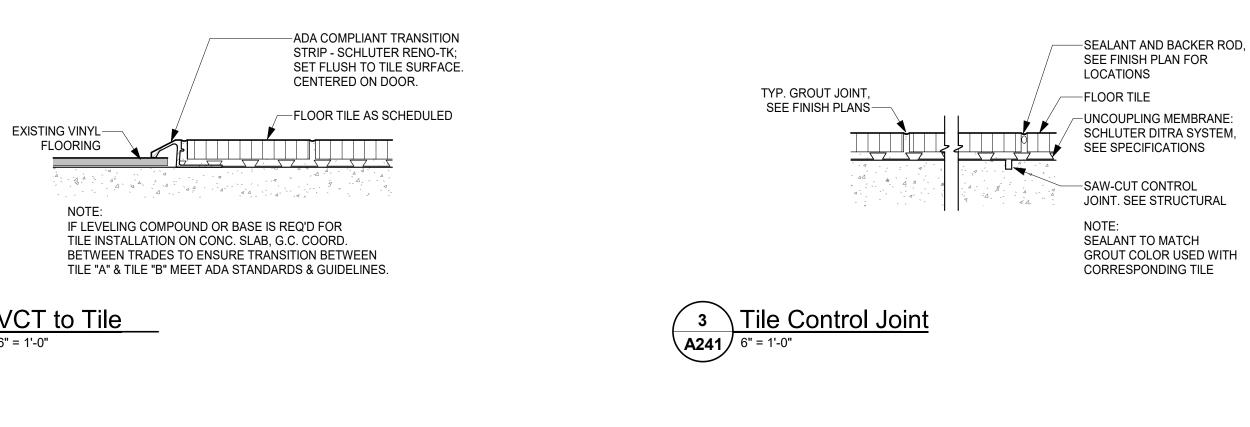

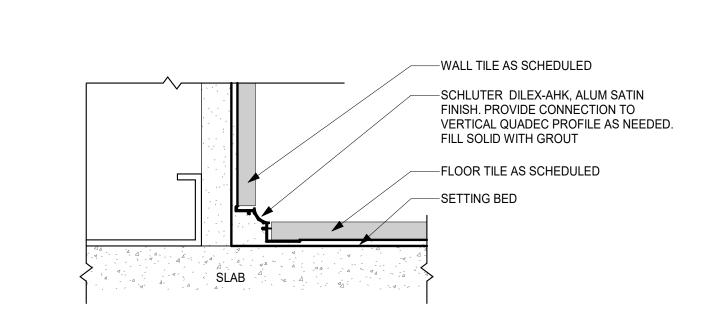

## **FINISH NOTES & LEGEND**

HATCH PATTERNS FOR TILE REPRESENT INTENDED SIZE AND DIRECTIONAL LAYOUT. NOTIFY ARCHITECT IF DESIGNED LAYOUT IS NOT ACHIEVABLE. ALL GROUT LINES ARE TO BE 1/8".

SEE X### FOR COMPLETE INTERIOR FINISH SCHEDULE

100 Peachtree St NW

BRIAN CHARLES TANNER

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ROOM NAME & NUMBER 

FL-# FLOOR FINISH

ACCENT FINISH INDICATOR

FINISH PATTERN DIRECTION

FLOOR FINISH TRANSITION


CORNER GUARDS

AREA NOT IN SCOPE

\*ALL EXISTING FINISHES IN AREAS NOT IN SCOPE THAT ARE IN PERMISSIBLE CONDITION, BY THE CLIENT, TO REMAIN. PROPOSED FINISHES ARE ADD ALTERNATES, ONLY IN THE CASE OF FINISHES NEEDING TO BE REPLACED.

#### FINISH KEYNOTES

F01	ALL FLOORING DEMOLISHED
	CONNECTED TO SEWER TO BE
	RECONNECTED WITH NEW FLOORIN
F02	ALL NEW FINISHES TO MATCH
	SURROUNDING EXISTING FINISHES.
	PATCH AND REPAIR EXISTING
	FLOORING AND PARTITIONS, AS
	NEEDED

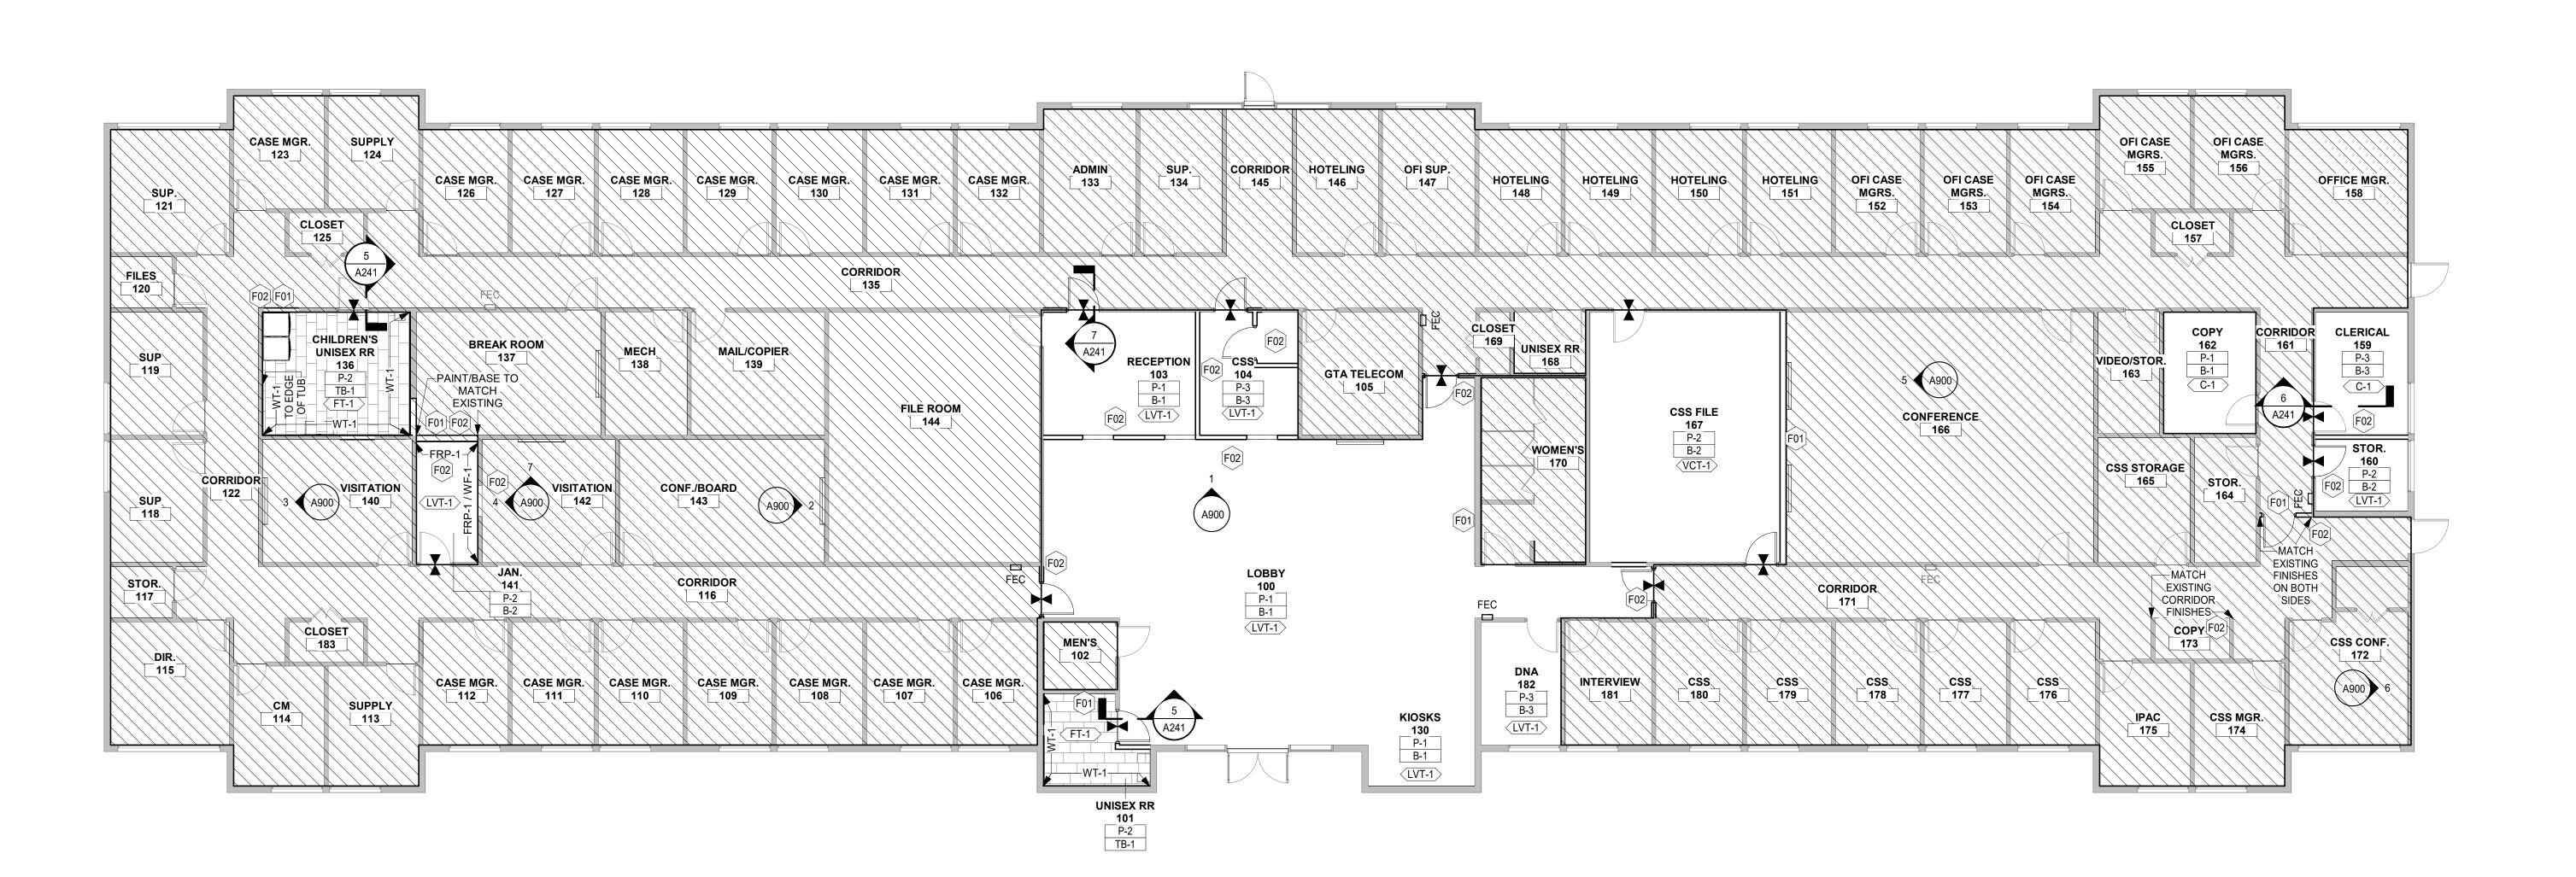

PORCELAIN WALL TILE,-

4 Tile Corner Detail
A241 6" = 1'-0"

SEE ELEVATION

**DEPARTMENT OF HUMAN SERVICES** 

Project Number: 23122 Project Name:

DHS ROCKDALE **COUNTY** 

975 SW Taylor Street, Conyers, GA 30012

Key Plan:

1 Finish Plan
A241 1/8" = 1'-0"

Sheet Title:
Finish Plan

Sheet Number:

#### **GENERAL POWER NOTES**


- 1. AT PRIVATE OFFICES, PROVIDE JUNCTION BOX AND 1" RIGID CONDUIT AND PULL STRING FOR TEL/DATA. 2. AT EACH CONFERENCE ROOM ONE JUNCTION BOX WITH CONDUIT
- AND PULL STRING FOR TELE/DATA. PROVIDE WALL-MOUNTED DUPLEX OUTLET AND DATA BACKBOX FOR TENANT'S WALL-MOUNTED FLAT SCREEN TELEVISION. 3. AT EACH LARGE CONFERENCE ROOM, PROVIDE ONE (1) FLUSH FLOOR POWER/TELE/DATA UNIT AND WIREMOLD "RC" SERIES ASSEMBLED UNIT #RC7ATCBK (BLACK FLANGE & SLIDE COVERS) FOR CARPETED FLOORS. AT SLAB ON GRADE CONDITIONS, PROVIDE THE EQUIVALENT UNIT. CUT AND RESTORE SLAB AS REQUIRED FOR INSTALLATION.
- 4. AT EACH CONFERENCE ROOM WITH AN ELECTRIC PROJECTION SCREEN, PROVIDE POWER AND TEL/DATA BOX ABOVE CEILING FOR TENANT PROVIDED CEILING MOUNTED PROJECTOR. 5. AT EACH TRAINING ROOM, PROVIDE DUPLEX OUTLET ALONG WITH BACKBOX, CONDUIT, AND PULL STRING FOR AGENCY'S WALL-MOUNTED TELEVISION. PROVIDE FIRE-RETARDANT BLOCKING WITHIN PARTITION FOR MOUNTING TELEVISION. 6. PROVIDE WALL MOUNTED POWER FEED AND ONE JUNCTION BOX WITH 1" RIGID CONDUIT AND PULL STRING FOR EVERY WORKSTATION CLUSTER THAT BACKS UP TO A PARTITION OR COLUMN. AT "FLOATING" CLUSTERS, PROVIDE POWER ABOVE CEILING FOR TENANT'S FURNITURE SYSTEM POWER POLES. PROVIDE WALL OR CEILING FEED FOR EVERY SIX (MAXIMUM) WORKSTATIONS. ASSUME TENANT'S WORKSTATION ELECTRICAL SYSTEM TO BE 8 WIRE, 4-CIRCUIT. THE GENERAL CONTRACTOR IS
- 7. ALL LOW-VOLTAGE CABLING WILL BE PROVIDED AND INSTALLED BY TENANT'S VENDOR. GENERAL CONTRACTOR TO COORDINATE WITH TENANT'S VENDOR FOR SCHEDULING AND APPROPRIATE ACCESS TO THE SPACE AS REQUIRED. 8. AT THE GTA TELECOM ROOM, PROVIDE THE FOLLOWING: (A) TWO (2) DEDICATED 20-AMP RECEPTACLES WITH NEMA TWIST LOCK FROM STRUCTURE ABOVE TO FEED RACKS. (B) TWO (2) DEDICATED QUAD OUTLETS. (C) ONE (1) DEDICATED DUPLEX OUTLET (FOR SECURITY PANEL). (D) THREE (3) COMMON DUPLEX
- OUTLETS. (E) MAIN GROUNDING BUSBAR, 12" × 4" × 1/4", PLATED COPPER. 9. AT EACH TEL/DATA RECEPTACLE, GENERAL CONTRACTOR TO PROVIDE BACKBOX WITHIN PARTITION WITH 1" RIGID CONDUIT TO ABOVE FINISHED CEILING WITH PULL STRING. REPLACE ANY EXISTING DEVICES TO REMAIN THAT DO NOT MEET THESE
- 10. AT RECEPTIONIST WINDOWS, PROVIDE ONE QUAD OUTLET AND ONE TEL/DATA OUTLET FOR EACH WINDOW SHOW. PROVIDE ONE ADDITIONAL DUPLEX OUTLET AND TEL/DATA OUTLET WITHIN THE SPACE. PROVIDE A RELEASE BUTTON FROM THE CUSTOMER SERVICE WINDOWS TO THE SECURED DOOR FROM WAITING TO OFFICE AREAS. 11. ALL FILE ROOMS ARE TO HAVE ONE DUPLEX OUTLET AND ONE TEL/DATA OUTLET FOR EVERY 200 S.F. OF SPACE.
- 12. WHERE VENDING MACHINES ARE INDICATED, PROVIDE DEDICATED DUPLEX OUTLETS. 13. PROVIDE GENERAL AREA CONVENIENCE OUTLETS EVERY 40 FT. MINIMUM.

RESPONSIBLE FOR HARD WIRED CONNECTION OF ALL POWER POLES.

- 14. ALL COPIERS ARE TO RECEIVE ONE DEDICATED DUPLEX OUTLET AND ONE JUNCTION BOX WITH CONDUIT AND PULL STRING. 15. AT EACH BREAKROOM, PROVIDE DEDICATED OUTLETS FOR ALL SPECIFIED APPLIANCES. PROVIDE DEDICATED OUTLET(S) EQUAL TO THE QUANTITY OF MICROWAVE OVENS. PROVIDE A MINIMUM OF TWO (2) QUAD OUTLETS ABOVE THE COUNTER AND A MINIMUM OF ONE (1) ADDITIONAL CONVENIENCE DUPLEX WITHIN THE ROOM. PROVIDE WALL MOUNTED OUTLET AND DATA BACKBOX FOR TENANT'S FLAT-SCREEN TELEVISION. 17. AT WAITING, PROVIDE TWO (2) DUPLEX OUTLETS AND TEL/DATA OUTLETS AND ONE (1) WALL-MOUNTED OUTLET AND DATA BACKBOX FOR TENANT'S FLAT SCREEN TELEVISION.
- 18. OUTLETS ARE TO BE MOUNTED ABOVE THE MILLWORK IN COPY ROOMS AND BREAKROOMS. 19. PROVIDE 2" CONDUIT FROM BUILDING DEMARK TO GTA TELECOM ROOM. CONDUIT TO BE GROUNDED TO A # 6 GROUND BAR.
- 20. WHERE SYSTEMS FURNITURE IS SHOWN, THE GENERAL CONTRACTOR IS RESPONSIBLE FOR HARD WIRED CONNECTION OF ALL BASE FEEDS AND POWER POLES. ONCE THE PANELS ARE INSTALLED, THE ELECTRICIAN IS TO RETURN AND CUT THE BASE FEED WHIPS TO A REASONABLE LENGTH. ALL WORK ASSOCIATED WITH THIS IS TO BE INCLUDED IN PRICING. 21. PROVIDE A PRICE FOR A NEW ELECTRICAL PANEL BOARD WITHIN THE TENANT'S SPACE IF SUFFICIENT CIRCUITS DO NOT EXIST IN THE EXISTING PANEL WITH SPARES FOR THE SPECIFIED ELECTRICAL LOAD.
- 22. ALL OUTLETS AND LIGHT SWITCHES ARE TO BE GREY WITH STAINLESS STEEL COVER PLATES (IF NOT IN CONFLICT WITH BUILDING STANDARDS). 23. EXISTING OUTLETS MAY REMAIN IF NOT IN CONFLICT WITH OTHER ITEMS. IF EXISTING OUTLET'S DO NOT MATCH STATE STANDARDS, REPLACE AS NECESSARY. PROVIDE BLANK PLATES FOR ANY EXISTING ABANDONED TELE/DATA LOCATIONS THAT DO NOT
- 24. VERIFY THAT ALL EXISTING POWER OUTLETS TO REMAIN ARE FULLY FUNCTIONAL AND REPAIR IF NECESSARY. 25. AT EACH BREAKROOM, PROVIDE STAINLESS STEEL ADA ACCESSIBLE SINGLE BOWL SINK AND "DANZE AMALFI" #D454530, SINGLE-HANDLE, PULL-DOWN FAUCET. 26. INCLUDE IN PRICING A NEW WATER HEATER(S) UNLESS IT IS CONFIRMED THAT AN EXISTING WATER HEATER IS PRESENT, LESS THAN 5 YEARS OLD AND IN PROPER WORKING CONDITION.
- 27. GENERAL CONTRACTOR IS RESPONSIBLE FOR ENSURING THAT ADEQUATE POWER IS PROVIDE, AS WELL AS WATER AND DRAINS, WHERE APPLICABLE IF APPLIANCES ARE REQUIRED BY THE TENANT. 28. THE GENERAL CONTRACTOR IS RESPONSIBLE FOR COORDINATING APPLIANCES WITH MILLWORK AND ENSURING THAT ADEQUATE CLEARANCES ARE PROVIDED.
- PROVIDE AN ADA COMPLIANT, DUAL-HEIGHT WATER COOLER WITHIN THE TENANT SPACE, NOT LESS THAN ONE (1) PER ONE HUNDRED (100) OCCUPANTS OR AS REQUIRED BY CODE. 29. PROVIDE A JANITOR SINK AND FAUCET WHERE INDICATED ON THE PLANS.
- 30. PROVIDE WATER LINE AND HOOK UPS TO REFRIGERATOR, TENANT'S COFFEE MAKER AND DISHWASHER. PROVIDE CUT-OFF VALVES TO ALL WATER LINES.

#### FFE & CASEWORK LEGEND

FURNITURE OR FIXTURE BY OWNER

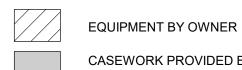

CASEWORK PROVIDED BY CONTRACTOR. SEE ELEVATIONS AND DETAILS



ABOVE COUNTER DUPLEX

DUPLEX


- DEDICATED DUPLEX
- QUADRAPLEX
- ABOVE COUNTER QUADRAPLEX
- DEDICATED QUADRAPLEX
- DATA

TELE/DATA

TELEVISION

PROJECTOR SCREEN

\*ALL EXISTING POWER/DATA IN AREAS NOT IN SCOPE THAT ARE IN PERMISSIBLE CONDITION, BY THE CLIENT, TO REMAIN. PROPOSED POWER/DATA ARE ADD ALTERNATES, ONLY IN THE CASE OF POWER/DATA NEEDING TO BE REPLACED OR ADDED.

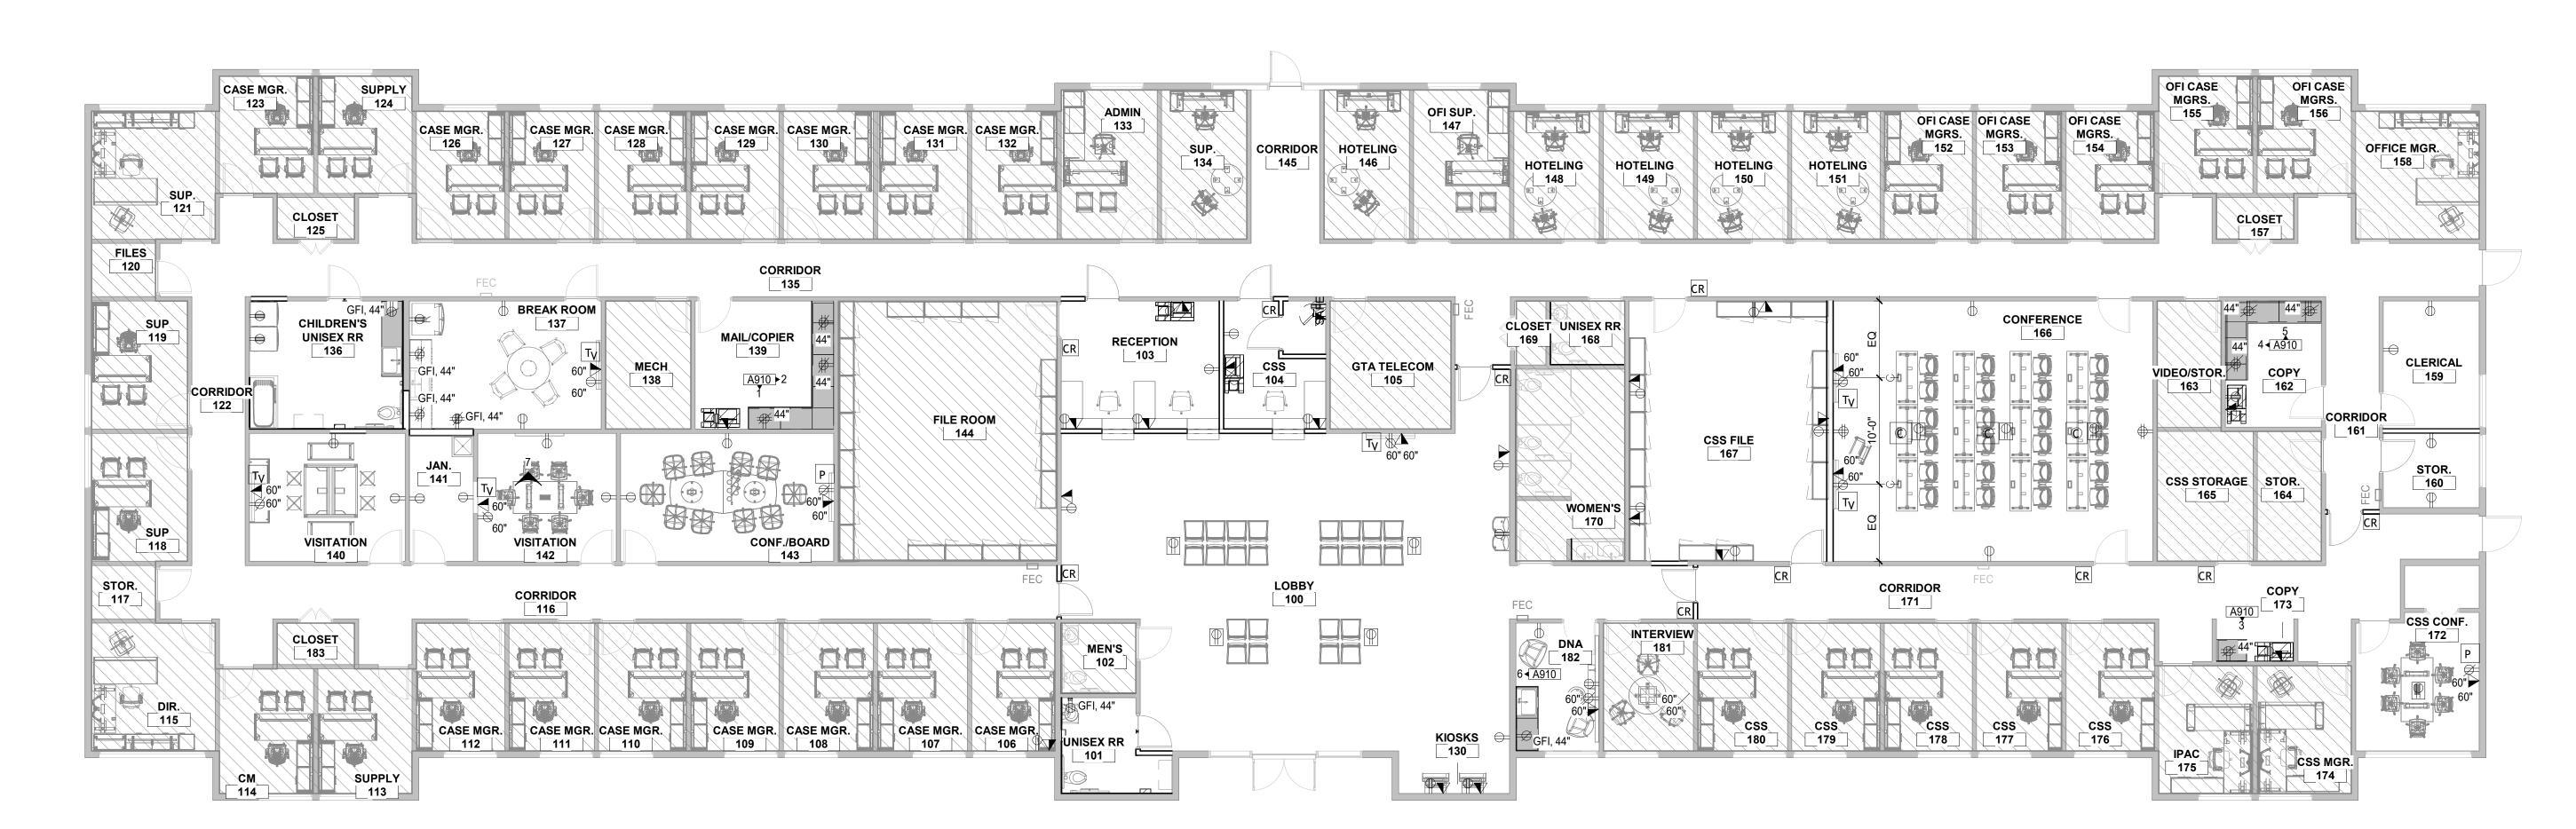




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**DEPARTMENT OF HUMAN SERVICES** 

Project Number: 23122 Project Name:

**COUNTY** 

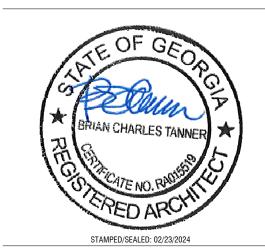DHS ROCKDALE

975 SW Taylor Street, Conyers, GA Key Plan:

FFE/PCP Plan

#### **GENERAL RCP NOTES**

- 1. PROVIDE MOTION-SENSOR LIGHT SWITCHES AT ALL OFFICES AND ENCLOSED ROOMS. REPLACE EXISTING SWITCHES AS REQUIRED.
  2. REWORK EXISTING CEILING TILE AND GRID AS REQUIRED BY DEMOTION AND NEW CONSTRUCTION. CEILING TILE TO MATCH EXISTING WITHIN THE
- 3. PROVIDE EMERGENCY LIGHTING AS REQUIRED TO MEET CODE. CONNECT FIXTURES TO BUILDING'S EMERGENCY CIRCUIT IF AVAILABLE OR PROVIDE ALTERNATIVE BATTERY PACK FIXTURES.

  4. AT THE END OF THE JOB, ALL LAMPS WITHIN FIXTURES ARE TO BE FULLY FUNCTIONAL AND OF THE SAME COLOR TEMPERATURE. REPLACE ALL LAMPS NOT MEETING THESE CRITERIA AS REQUIRED.
- NOT MEETING THESECRITERIA AS REQUIRED.
  5. PROVIDE ONE (1) DA-LITE "BOARDROOM ELECTROL" ELECTRIC PROJECTION SCREEN (OR APPROVED EQUAL IN QUALITY AND FUNCTION) TO BE LOCATED IN EACH TRAINING ROOM AND/OR LARGE CONFERENCE ROOM. CUT AND MODIFY CEILING GRID AS REQUIRED.
  6. RESTORE CEILING GRID TO "LIKE NEW" CONDITION INCLUDING REMOVING ALL MARKS OR DAMAGE. REPAINT EXISTING GRID IF DISCOLORED. FILL AND
- PAINT ANY SCREW HOLES.

  7. REUSE EXISTING CEILING TILE TO THE FULLEST EXTENT POSSIBLE. REPLACE ALL DAMAGED OR DISCOLORED TILES WITH NEW TO MATCH EXISTING AS REQUIRED. THE MIXING OF OLD AND NEW TILES WITHIN ONE SPACE IS NOT ACCEPTABLE.

  8. EXISTING GRID IS TO BE STRAIGHTENED AND LEVELED AS REQUIRED. REPLACE ANY DAMAGED OR DISCOLORED MEMBERS.

  9. MATCH EXISTING CEILING HEIGHTS, TYP.

## RCP LEGEND

CEILING FINISH MATERIAL

F-# #-#" 

CEILING ELEVATION

RETURN DIFFUSER

SUPPLY DIFFUSER

ROLLER WINDOW SHADE M - MOTORIZED

EXIT SIGN

2' X 2' LED LIGHT FIXTURE
2' X 4' LED LIGHT FIXTURE

6" X 4' LED LIGHT FIXTURE


## Ceiling Schedule


ACP-1 2'x2' ACOUSTICAL CEILING PANEL SYSTEM

## RCP KEYNOTES

R03 REPAIR AND REPLACE CEILING WHERE NECESSARY.

R04 REPAIR CEILING WHERE DAMAGED FROM CONSTRUCTION ON BOTH SIDES
OF NEW PARITION. CEILING GRID TO MATCH EXISTING, WITHOUT
OBSTRUCTION TO LIGHTING OR HVAC FROM NEW PARTITION LOCATION.

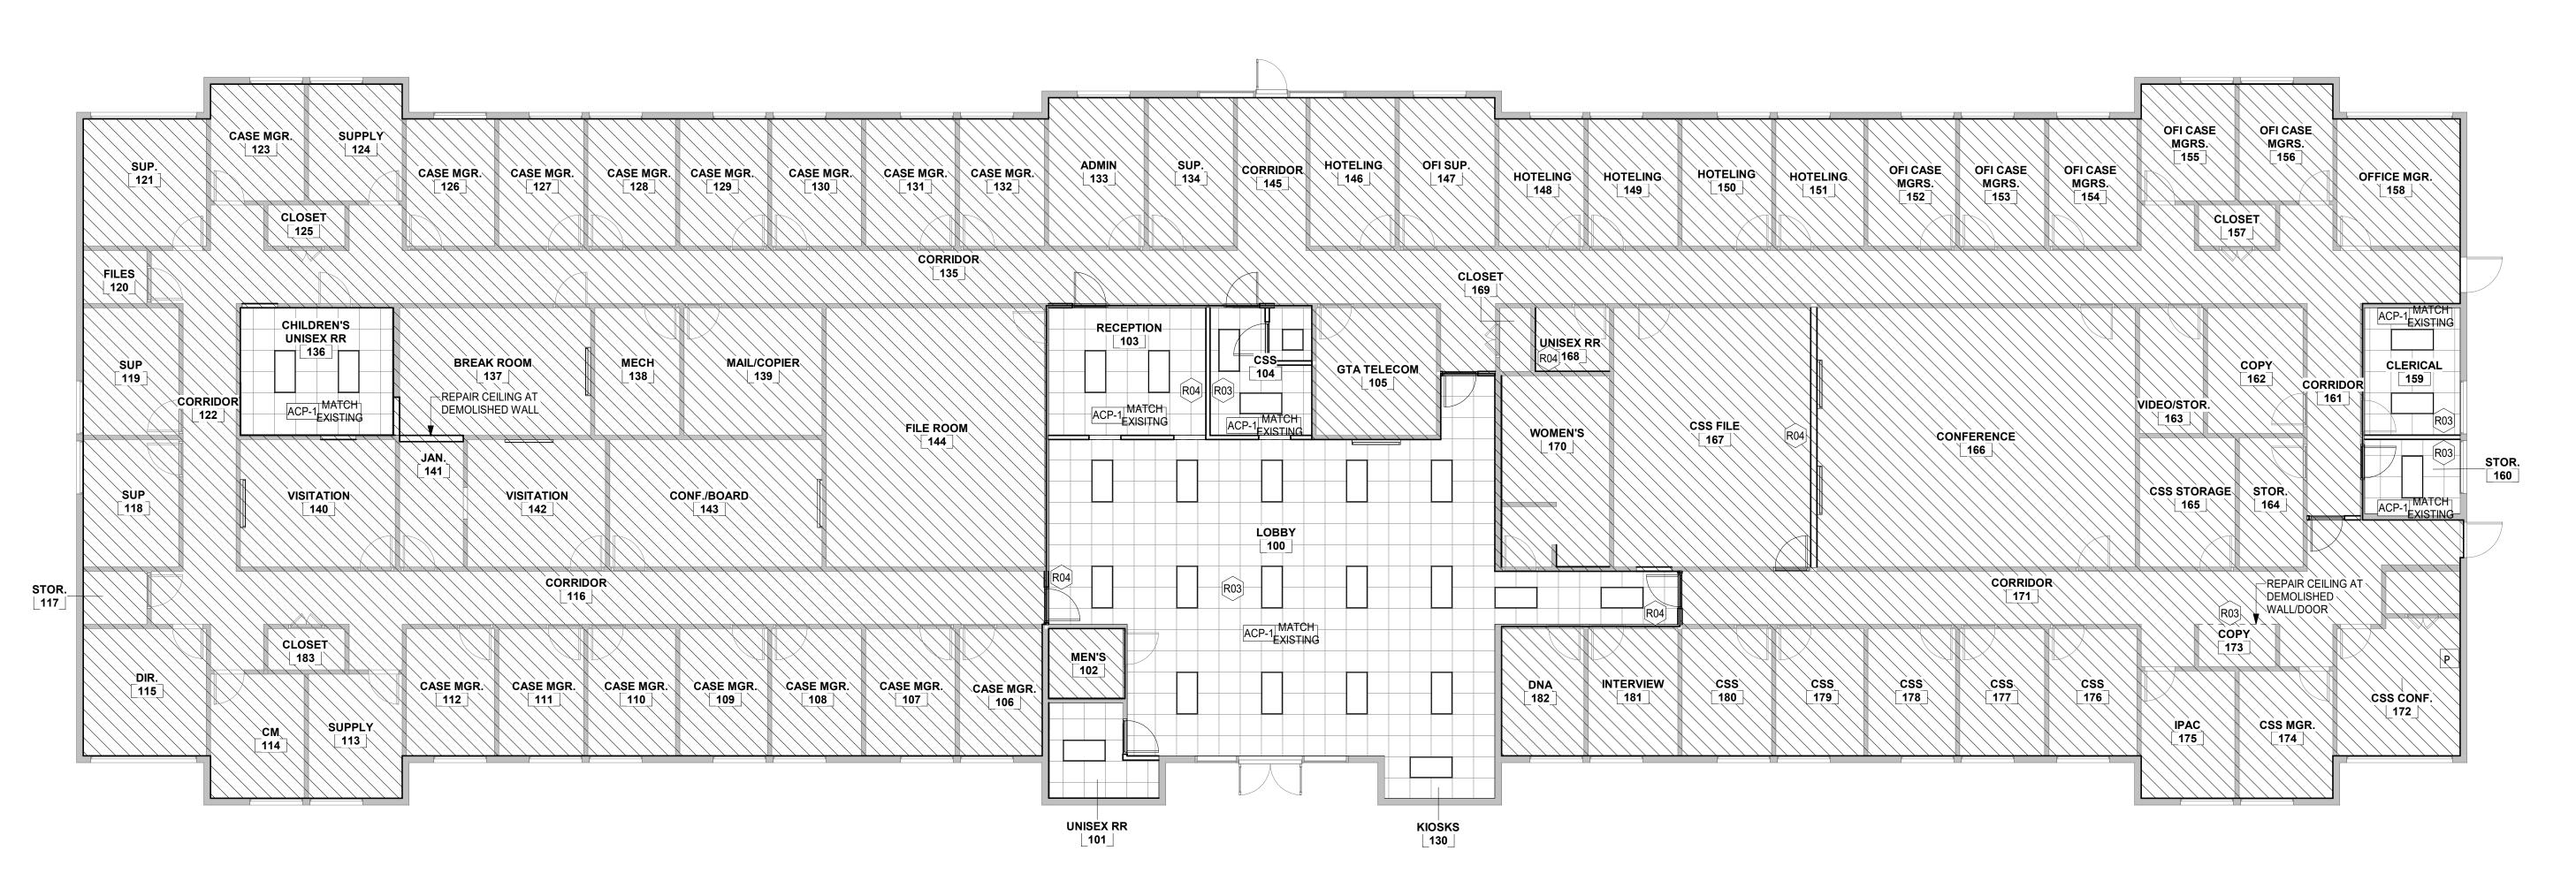

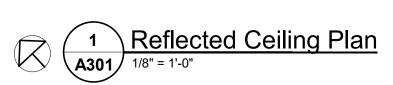

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OF CA

BRIAN CHARLES TANNER \*

BRIAN CHARLES TANNER \*

CONTRACTOR OF CATE NO. RANGES | 100 CATE

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# DEPARTMENT OF HUMAN SERVICES

Project Number: 23122 Project Name:

# DHS ROCKDALE COUNTY

975 SW Taylor Street, Conyers, GA 30012

Key Plan:

Reflected Ceiling
Plan


Sheet Number:

## INTERIOR FINISH SCHEDULE

—							
	CODE	MATERIAL	MANUFACTURER	PATTERN	COLOR	SIZE/DESCRIPTION	LOCATION
WALL FINISHES	FRP-1	PANELS	MATCH EXISTING	MATCH EXISTING	MATCH EXISTING	4'-0"H AT SINK LOCATION	JANITOR CLOSET
	P-1	PAINT	MATCH EXISTING	MATCH EXISTING	MATCH EXISTING	ONE COAT OF PRIMER AND TWO COATS (MINIMUM) OF FINISH PAINT.	GENERAL PAINT
	P-2	PAINT	MATCH EXISTING	MATCH EXISTING	MATCH EXISTING	ONE COAT OF PRIMER AND TWO COATS (MINIMUM) OF FINISH PAINT.	BREAK ROOM, RESTROOM, JANITOR CLOSET
	P-3	PAINT	MATCH EXISTING	ACCENT PAINT	MATCH EXISTING	ONE COAT OF PRIMER AND TWO COATS (MINIMUM) OF FINISH PAINT.	ACCENT PAINT
	WF-1	WINDOW FILM	3M OR EQUAL	PRIVACY FILM	MATCH EXISTING	PRIVACY FILM AT WINDOW LOCATION	JANITOR CLOSET TO VISITATION ROOM
	WT-1	WALL TILE	MATCH EXISTING	MATCH EXISTING	MATCH EXISTING	MATCH EXISTING	RESTROOM
FLOOR FINISHES	C-1	CARPET	MATCH EXISTING	MATCH EXISTING	MATCH EXISTING	LEVEL LOOP, 26 OZ, STAIN RESISTANT. DIRECT GLUE CARPET INSTALLATION WITH NO PAD. PREP FLOOR AND	OFFICES, COPY
	FT-1	CERAMIC FLOOR TILE	MATCH EXISTING	MATCH EXISTING	MATCH EXISTING	12" X 24". ENTRY TO RESTROOMS TO HAVE FULL-WIDTH MARBLE THRESHOLD.	RESTROOMS
	LVT-1	LUXURY VINYL TILE	MANNINGTON	UPWARD 20	SILVER BEECH UPW20 1210	6" X 36", UNBEVELED, INSTALL PER MANUFACTURER'S INSTRUCTIONS.	LOBBY, DNA, AND JANITOR CLOSET
	VCT-1	VINYL COMPOSITE TILE	ARMSTRONG	EXCELON OR EQUAL	MATCH EXISTING	THOROUGHLY CLEAN AND WAX AFTER COMPLETION OF INSTALL.	BREAK ROOM, RECEPTION AREA, FILE ROOM, AND STORAGE
	B-1	RUBBER BASE	MATCH EXISTING	CONTINUOUS, ROLLED STRAIGHT BASE	MATCH EXISTING	4"H WITH PRE-FORMED CORNERS, AT CARPET.	LOBBY
L BASES -	B-2	RUBBER BASE	MATCH EXISTING	CONTINUOUS, ROLLED COVE BASE	MATCH EXISTING	4"H WITH PRE-FORMED CORNERS, AT VCT.	BREAK ROOM, RECEPTION, TELECOM ROOM
LL BASES	B-3	RUBBER BASE	MATCH EXISTING	CONTINUOUS, ROLLED STRAIGHT BASE	MATCH EXISTING	4"H WITH PRE-FORMED CORNERS, AT CARPET.	OFFICES
	TB-1	TILE BASE	MATCH EXISTING	COVED TILE BASE	MATCH EXISTING	4"H, CORRESPONDS TO FT-1	RESTROOM
CEILINGS	ACP-1	ACOUSTIC CEILING PANELS	MATCH EXISTING	MATCH EXISTING	MATCH EXISTING	2' X 2'	THROUGHOUT
	GB-1	GYPSUM CEILING	MATCH EXISTING	MATCH EXISTING	MATCH EXISTING	MATCH EXISTING	THROUGHOUT
SEWORK, LWORK, &	PL-1	PLASTIC LAMINATE	MATCH EXISTING	MATCH EXISTING	MATCH EXISTING	MATCH EXISTING	CABINETS
URNITURE	PL-2	PLASTIC LAMINATE	MATCH EXISTING	MATCH EXISTING	MATCH EXISTING	MATCH EXISTING	COUNTERTOPS
FINISHES	MP-1	MILLWORK PULL	MATCH EXISTING	MATCH EXISTING	MATCH EXISTING	MATCH EXISTING	CABINETS

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**DEPARTMENT OF HUMAN SERVICES** 

Project Number: 23122 Project Name:

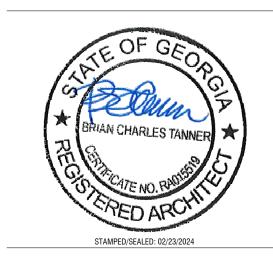DHS ROCKDALE COUNTY

975 SW Taylor Street, Conyers, GA 30012

Key Plan:

Interior Finish
Schedule

Sheet Number:

#### **INTERIOR SIGNAGE**

THE FOLLOWING SIGNAGE TO BE ASI INTOUCH BY ASI SIGN SYSTEMS (OR APPROVED EQUAL)

- S-20 WOMEN'S RESTROOM ID: SIGN WITH THE WORD "WOMEN", 1" HIGH RAISED HELVETICA LETTERS AND BRAILLE CHARACTERS WITH PICTOGRAM FOR A WOMAN AND A HANDICAP-ACCESSIBLE SYMBOL. LOCATION: MOUNT ON THE WALL (LATCH SIDE). CENTER SIGN AT 60" AFF, MAXIMUM.
- S-21 MEN'S RESTROOM ID: SIGN WITH THE WORD "MEN", 1" HIGH RAISED HELVETICA LETTERS AND BRAILLE CHARACTERS WITH PICTOGRAM FOR A MAN AND A HANDICAP-ACCESSIBLE SYMBOL. LOCATION: MOUNT ON THE WALL (LATCH SIDE). CENTER SIGN AT 60" AFF, MAXIMUM.
- S-22 UNISEX ADA RESTROOM ID: SIGN WITH THE WORD "UNISEX", 1" HIGH RAISED HELVETICA LETTERS BRAILLE CHARACTERS WITH PICTOGRAM FOR A PERSON AND A HANDICAP-ACCESSIBLE SYMBOL. LOCATION: MOUNT ON THE WALL (LATCH SIDE). CENTER SIGN AT 60" AFF, MAXIMUM.
- S-23 UNISEX RESTROOM ID: SIGN WITH THE WORD "UNISEX", 1" HIGH RAISED HELVETICA LETTERS AND BRAILLE CHARACTERS. LOCATION: MOUNT ON THE WALL (LATCH SIDE). CENTER SIGN AT 60" AFF, MAX
- S-25 STAIR DOOR ID: SIGN WITH THE WORD "STAIRS", 1" HIGH RAISED HELVETICA LETTERS AND BRAILLE CHARACTERS WITH PICTOGRAM OF STAIR. LOCATION: MOUNT ON THE WALL (LATCH SIDE). LOCATED IN SUCH THAT THE BOTTOM OF THE TEXT IS AT 48" A.F.F. MIN
- S-26 ENTRY PROHIBITION: "AUTHORIZED PERSONNEL ONLY" IN 1" HIGH RAISED HELVETICA LETTERS WITH BRAILLE CHARACTERS AND SYMBOL FOR NO ENTRY. LOCATION: MOUNT ON THE CENTER OF THE DOOR AT 60" AFF, MAX
- S-27 EGRESS STOREFRONT DOORS: STENCILED LETTERS ADHERED TO GLASS "THESE DOORS TO

#### **GENERAL DOOR NOTES**

LOCATIONS AND QUANTITY.

- 1. ALL DOORS ARE TO BE A MINIMUM OF 3'-0" WIDE × 7'-0" HIGH AND OF SOLID CORE CONSTRUCTION. DOORS MAY BE STAINED OR CLEAR VENEER FINISH. PAINT GRADE DOORS WILL ALSO BE ACCEPTABLE IF MATCHING EXISTING.
- 2. EXISTING DOORS WITHIN THE SPACE MAY BE REUSED IF MEETING MINIMUM STANDARDS. DOORS ARE TO BE TOUCHED-UP AS REQUIRED TO ACHIEVE "BEST POSSIBLE" APPEARANCE PER STANDARD REQUIREMENTS. 3. DOORS ARE TO BE SET IN HOLLOW METAL FRAMES. FRAMES CAN BE WELDED OR
- KNOCK-DOWN. 4. PROVIDE ADA COMPLIANT LEVER HARDWARE THROUGHOUT. HARDWARE TO MEET A MINIMUM STANDARD OF ANSI GRADE II, LIGHT COMMERCIAL. EXISTING HARDWARE MAY
- BE REUSED IF IN PROPER WORKING ORDER. 5. FINISH OF DOOR HARDWARE TO MATCH EXISTING IF REUSED FROM WITHIN THE SPACE. 6. PROVIDE 20-MINUTE RATED DOORS AND HARDWARE AT ALL DOORS IN 1-HOUR RATED PARTITIONS OR AS REQUIRED BY CODE. PROVIDE NON-RATED DOORS WITH CLOSERS AT ALL SMOKE PARTITIONS AND GTA TELECOM ROOM. 7. PROVIDE LOCKS AT THE FOLLOWING SPACES: GTA TELECOM ROOMS, STORAGE ROOMS,

FILE ROOMS, AND PRIVATE OFFICES. AT SINGLE PERSON TOILETS, PROVIDE "PRIVACY

HAVE ADA COMPLIANT SIGNAGE AND INTERNATIONAL HANDICAP ACCESSIBILITY SYMBOL.

CONTRACTOR IS TO PROVIDE ALL INFRASTRUCTURE AS REQUIRED. THIS SHALL INCLUDE

A BACKBOX WITH PULL STRING FOR CARD READER AND POWER ABOVE CEILING AS REQUIRED. AT SINGLE DOORS, GENERAL CONTRACTOR TO PROVIDE THE ELECTRIC STRIKE WITHIN THE DOOR FRAME FOR CONNECTION BY THE TENANT'S SECURITY VENDOR. AT DOUBLE DOORS, THE SECURITY VENDOR WILL PROVIDE MAG LOCKS. ALL DOORS WITH CARD READERS ARE TO BE CONNECTED TO THE BUILDING'S FIRE ALARM

SYSTEM TO RELEASE IN THE EVENT OF AN ALARM. SEE PLAN FOR CARD READER

10. THE TENANT'S VENDOR WILL INSTALL THE SECURITY SYSTEM. THE GENERAL

- FUNCTION" LOCKSET ON DOORS. 8. AT BREAKROOMS AND MULTI-FIXTURE TOILETS, PROVIDE PUSH/PULL SETS AND CLOSER ON DOORS. 9. IF THE MAIN ENTRY DOOR IS EXTERIOR, PROVIDE ADA POWER ASSIST OPENING UNIT WITH ACTIVATION BUTTONS ON THE INSIDE AND OUTSIDE OF THE SPACE. BUTTON TO
- REMAIN UNLOCKED WHEN BUILDING IS OCCUPIED" IN 1" HIGH HELVETICA LETTERS, COLOR: WHITE.

#### DOOR SCHEDULE

	DOOR				FRA	AME		
NUMBER	TYPE	WIDTH	HEIGHT	FINISH	MATERIAL	TYPE	HARDWARE SET	COMMENTS
100A	D01	3'-0"	7'-0"	STAINED OR CLEAR VENEER	НМ	FH2	TBD	FRAME FINISH: MATCH EXISTING, INSTALL CARD READER
100B	D01	3'-0"	7'-0"	STAINED OR CLEAR VENEER	НМ	FH2	TBD	FRAME FINISH: MATCH EXISTING, INSTALL CARD READER
100C	D01	3'-0"	7'-0"	STAINED OR CLEAR VENEER	НМ	FH2	TBD	FRAME FINISH: MATCH EXISTING, INSTALL CARD READER
101	D01	3'-0"	7'-0"	STAINED OR CLEAR VENEER	НМ	FH2	TBD	FRAME FINISH: MATCH EXISTING
103	D01	3'-0"	7'-0"	STAINED OR CLEAR VENEER	НМ	FH2	TBD	FRAME FINISH: MATCH EXISTING
104A	D01	3'-0"	7'-0"	STAINED OR CLEAR VENEER	НМ	FH2	TBD	USE SALVAGED DEMOLISHED DOOR AND RELOCATE
104B	D01	3'-0"	7'-0"	STAINED OR CLEAR VENEER	НМ	FH2	TBD	FRAME FINISH: MATCH EXISTING, INSTALL CARD READER
159	D01	3'-0"	7'-0"	EXISTING	EXISTING	EXISTING	EXISTING	EXISTING DOOR, TO BE FLIPPED TO OPEN IN OPPOSITE DIRECTION
160	D01	3'-0"	7'-0"	STAINED OR CLEAR VENEER	НМ	FH2	TBD	FRAME FINISH: MATCH EXISTING
161	D01	3'-0"	7'-0"	STAINED OR CLEAR VENEER	НМ	FH2	TBD	FRAME FINISH: MATCH EXISTING, INSTALL CARD READER
167	D01	3'-0"	7'-0"	STAINED OR CLEAR VENEER	НМ	FH2	MATCH OPPOSITE DOOR, 167X	FRAME FINISH: MATCH EXISTING



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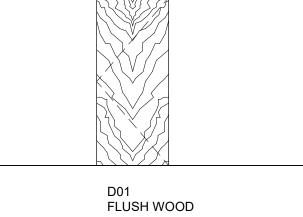



Stand Alone Frame Types

A510 1/4" = 1'-0"

FH2





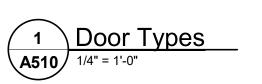

DHS ROCKDALE

Project Number: 23122 Project Name:

**COUNTY** 

**DEPARTMENT OF** 


**HUMAN SERVICES** 

975 SW Taylor Street, Conyers, GA

Key Plan:

Door Schedule & **Door Types** 

Sheet Number:

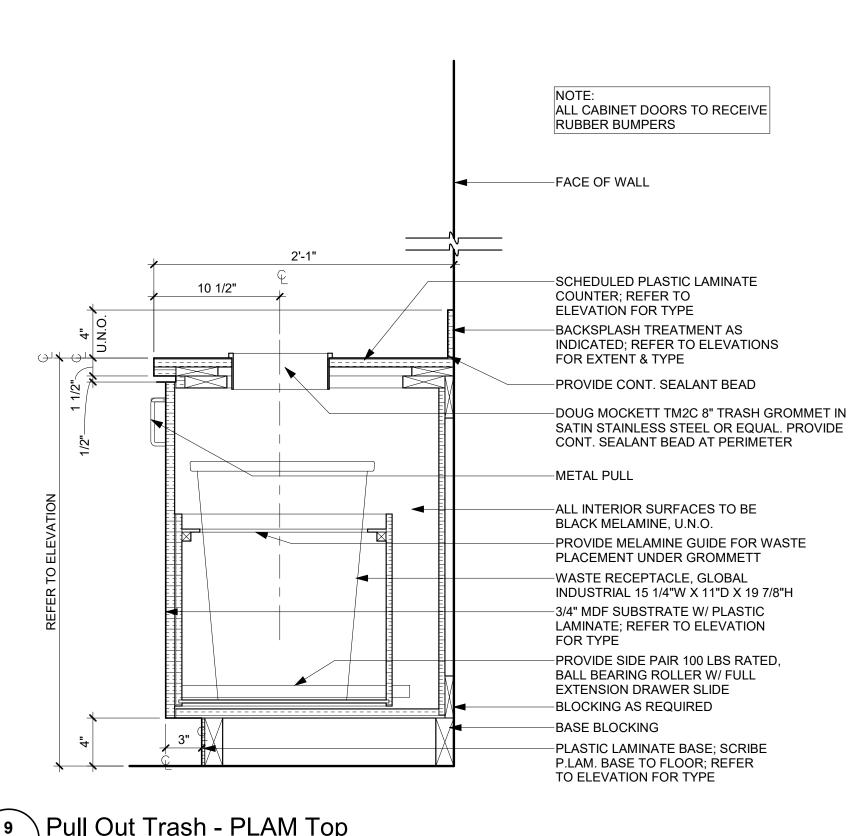


#### **GENERAL MILLWORK NOTES**

1. AT EACH BREAK ROOM, PROVIDE PLASTIC LAMINATE CLAD UPPER CABINETS WITH DOORS AND TWO (2) ADJUSTABLE SHELVES AND BASE CABINETS WITH DOORS AND ONE ADJUSTABLE SHELF, EXTENT AS SHOWN. PROVIDE ONE BANK OF DRAWERS 24" WIDTH AT BASE CABINET AREA. INTERIOR TO BE WHITE MELAMINE. 2. EACH BREAKROOM IS TO HAVE A FULLY ADA ACCESSIBLE SINK AREA, 34" HIGH × 36" MINIMUM WIDE. CABINET TO BE OPEN TO THE FLOOR BELOW WITH DOORS WITH APPLIED TOE-KICK. PROVIDE INSULATION ON P-TRAP

3. AT NEW MULTI-FIXTURE RESTROOMS, PROVIDE PLASTIC LAMINATE LAVATORY COUNTER WITH SET-IN SINKS. VANITY TO HAVE REMOVABLE PLASTIC LAMINATE PANEL TO SHIELD DRAINS. LAVATORY COUNTERS TO BE FULLY HANDICAP ACCESSIBLE AND IN COMPLIANCE WITH ALL ADA CLEARANCES. 4. AT COPY/FAX ROOMS PROVIDE PLASTIC LAMINATE CLAD BASE CABINETS AND UPPER CABINETS WITH DOORS AND ONE (1) ADJUSTABLE SHELF, EXTENT AS SHOWN. INTERIOR TO BE MELAMINE. 5. WHERE MILLWORK IS EXISTING TO REMAIN, UNITS ARE TO BE THOROUGHLY CLEANED. ALL MISSING OR MALFUNCTIONING HARDWARE IS TO BE REPLACED. LEVEL AND REALIGN ALL DOORS AND DRAWER FRONTS. REPAIR/REATTACH ANY EXISTING MILLWORK WITH DELAMINATING SURFACES.

### PLUMBING FIXTURES AND ACCESSORIES DIAGRAMS

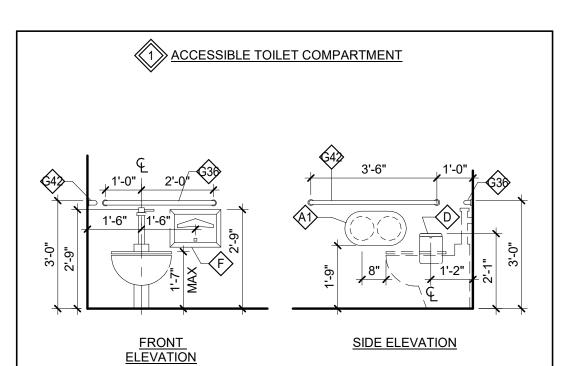

CODE	DESCRIPTION	MANUFACTURER	MODEL	NOTES
A1	SURFACE MOUNTED TOILET TISSUE DISPENSER FOR TWIN JUMBO ROLLS	BOBRICK	B-2892	21" AFF TO DISPENSING POINT, STAINLESS STEEL
В	SURFACE-MOUNTED PAPER TOWEL DISPENSER AND WASTE RECEPTACLE	BOBRICK	B-380349	44" MAX AFF WHERE PAPER IS DISPENSED (ASSUMES NO OBSTRUCTIONS), STAINLESS
С	SURFACE-MOUNTED PAPER TOWEL DISPENSER/WASTE RECEPTACLE	BOBRICK	B-72974	44" MAX AFF WHERE PAPER IS DISPENSED
D	SURFACE-MOUNTED SANITARY NAPKIN DISPOSAL	BOBRICK	B-254	STAINLESS STEEL
F	SURFACE-MOUNTED SEAT COVER DISPENSER (ADA)	BOBRICK	B-4221	
G18	18" GRAB BAR (SATIN FINISH)	BOBRICK	B-5806	
G36	36" GRAB BAR (SATIN FINISH)	BOBRICK	B-6806	
G42	42" GRAB BAR (SATIN FINISH)	BOBRICK	B-6806 X 42"	
H1	SURFACE-MOUNTED AUTOMATIC SOAP DISPENSER	BOBRICK	B-2012	BOTTOM TO ALIGN WITH BOTTOM OF MIRROR
J1	SURFACE-MOUNTED HORIZONTAL BABY CHANGING STATION	KOALA	KB300-33	FINISH: STAINLESS STEEL VENEER/WHITE GRANITE
K	24" X 36" MIRROR	BOBRICK	B-165	TO BE CENTERED OVER SINK
L	DIAPER DISPENSER	KOALA CARE	KB143-SS	STAINLESS STEEL
М	ноок	BOBRICK	B-76727	44" MAX AFF, MOUNTED ON BACK OF DOOR

### **GENERAL RESTROOM NOTES**

1. ALL EXISTING RESTROOMS AND TOILETS TO REMAIN ARE TO BE FULLY ADA COMPLIANT TO CURRENT STANDARDS. IF NOT, THEY ARE TO BE REWORKED AS REQUIRED AND/OR ACCESSORIES INSTALLED TO MEET ADA STANDARDS. 2. WITHIN ALL EXISTING RESTROOMS AND TOILETS TO REMAIN, ALL TOILET PARTITIONS ARE TO BE IN "LIKE-NEW CONDITIONS", FREE OF MARKS, CHIPS, OR OCCLUSIONS. ALL HARDWARE IS TO BE IN FULLY

FUNCTIONAL ORDER AND NOT LOSE OR MISALIGNED. REPLACE TOILET PARTITION WITH NEW IF REQUIRED. 3. PROVIDE SLIDE LATCH AND COAT HOOD ON EACH STALL

4. AT MULTI-FIXTURE RESTROOMS, PROVIDE FLOOR DRAINS AT EACH RESTROOM. 5. RESTROOMS ARE TO HAVE FLOOR DRAINS WHEREVER POSSIBLE. 6. THE FOLLOWING ARE INTENDED AS A GUIDELINE FOR

INTENT AND QUALITY. ALTERNATE ITEMS WILL BE CONSIDERED FOR USE IF OF EQUAL OR SUPERIOR QUALITY. 7. FLOOR-MOUNTED TOILET: AMERICAN STANDARD "CADET FLOWWISE" ELONGATED BOWL PRESSURE ASSISTED 1.1 GPF" UNIT WITH OPEN FRONT SEAT AND LID. PROVIDE HANDICAP HEIGHT MODEL WHERE

8. COUNTERTOP SINK: AMERICAN STANDARD "CADET EVERCLEAN" WITH FAUCET HOLES ON 4" CENTERS AND AMERICAN STANDARD "SEVA" FAUCET ASSEMBLY WITH SINGLE LEVER AND POP-UP DRAIN.

9. WALL HUNG LAVATORY: AMERICAN STANDARD


"LUCERNE" WITH FAUCET HOLES ON 4" CENTERS AND 7. 10. AMERICAN STANDARD "PRINCETON" FAUCET ASSEMBLY WITHLEVER HANDLES AND POP-UP DRAIN.



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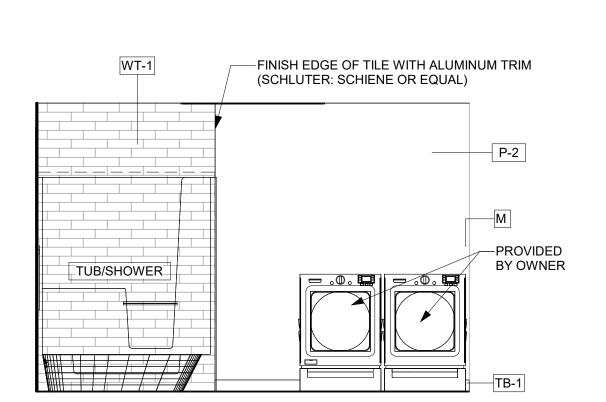
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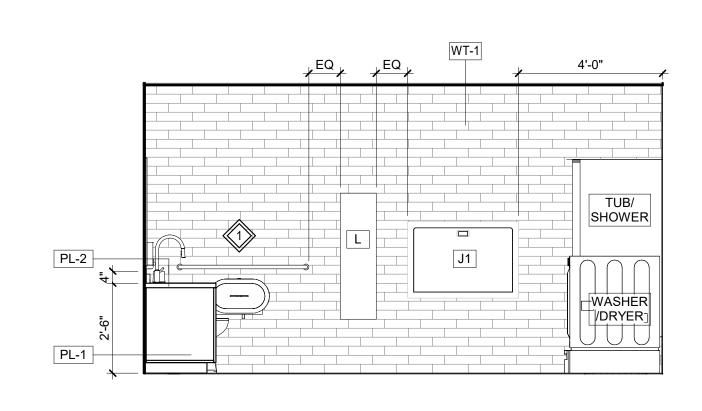
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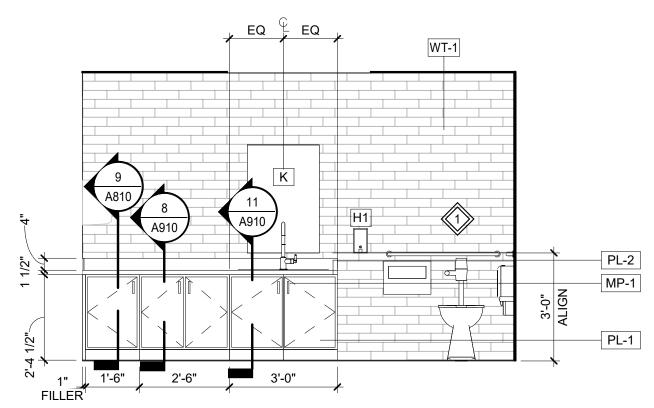
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7 Children's RR 136 - Elevation 02
A810 3/8" = 1'-0"



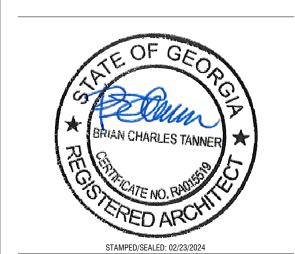


ATTACH HOOK TO INSIDE OF DOOR, CENTERED AND MOUNTED ON DOOR @ 48" AFF


3 Enlarged Plan - RR 136 A810 3/8" = 1'-0"

EQ EQ


CHILDREN'S UNISEX RR 136

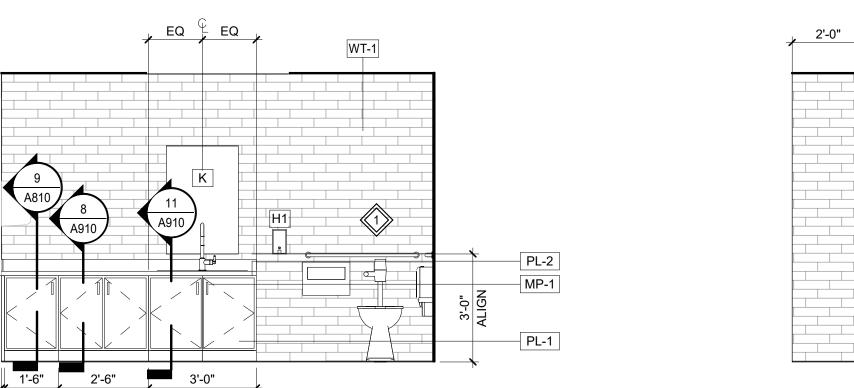




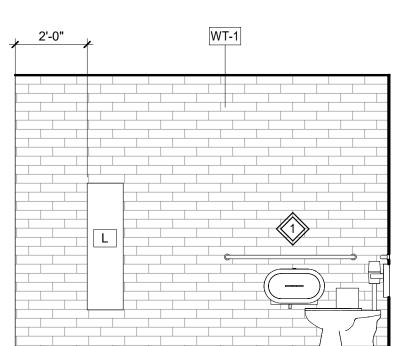



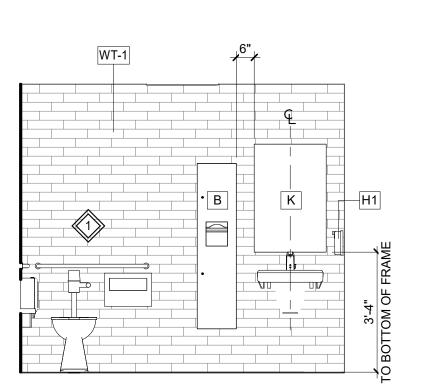



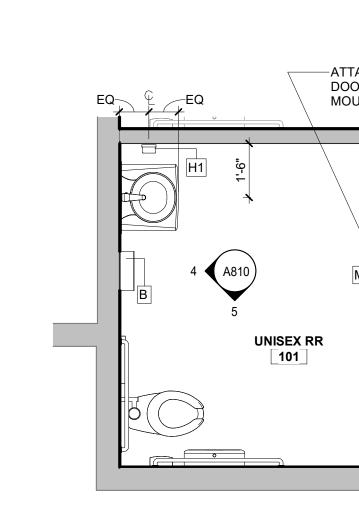

2 Enlarged Plan - RR 101 A810 3/8" = 1'-0"



Sheet Title: **Enlarged Restroom Plans** & Elevations

**DEPARTMENT OF** 


**HUMAN SERVICES** 


Project Number: 23122 Project Name:


**COUNTY** 


DHS ROCKDALE


Sheet Number:

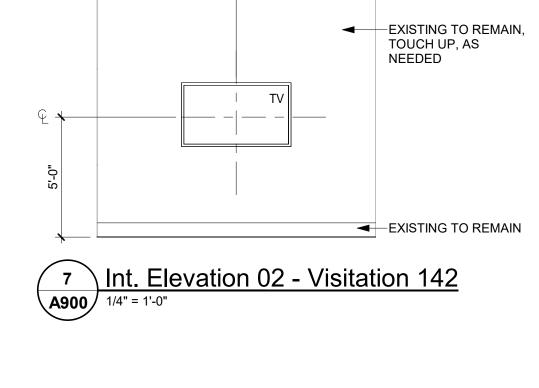

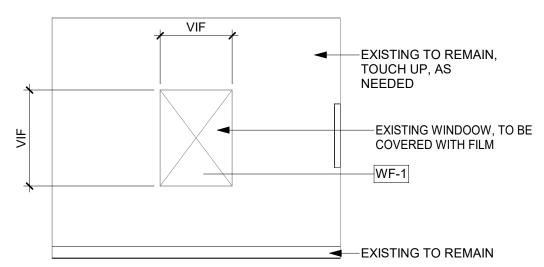

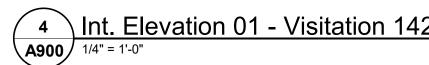

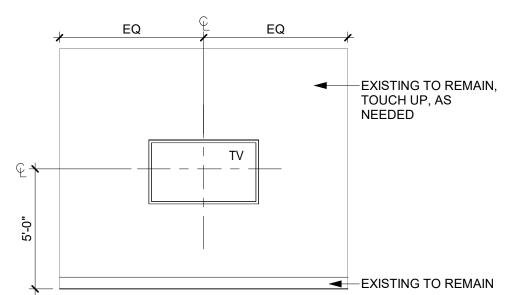

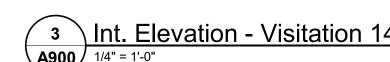

EXISTING TO REMAIN, TOUCH UP, AS NEEDED

—DROP DOWN PROJECTOR


EXISTING TO REMAIN


——PAINT TO MATCH ADJACENT PARTITION

BASE TO MATCH
ADJACENT PARTITION


6 Int. Elevation - CSS Conf. 172 A900 1/4" = 1'-0"


5 Int. Elevation - Conference 166 A900 1/4" = 1'-0"

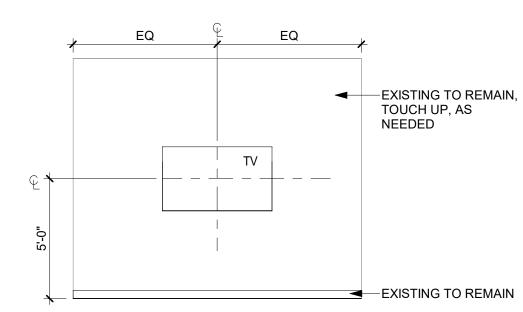


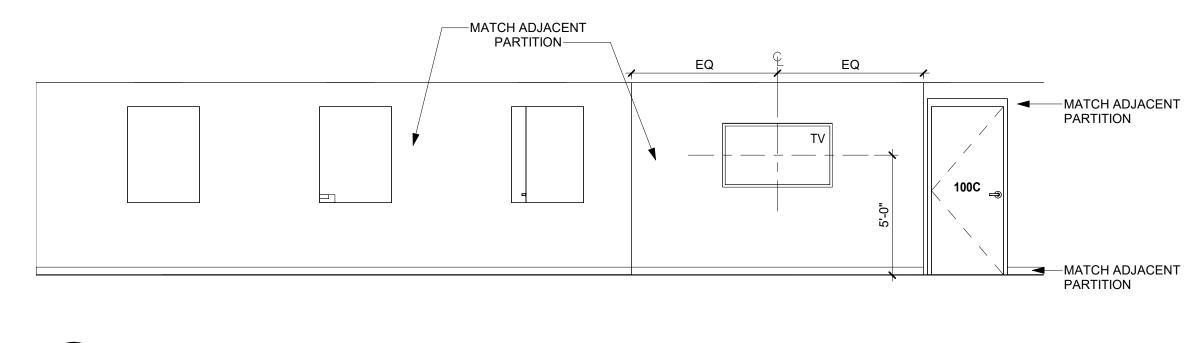



1 Int. Elevation - Reception A900 1/4" = 1'-0"

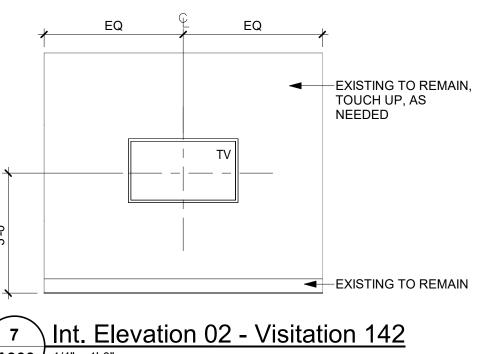


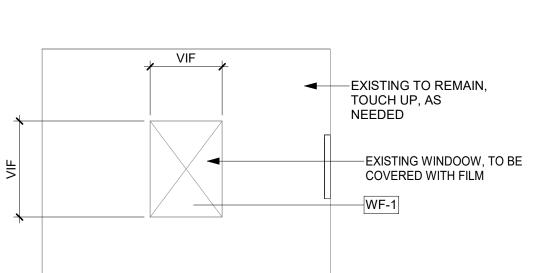

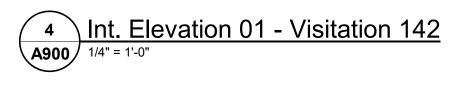

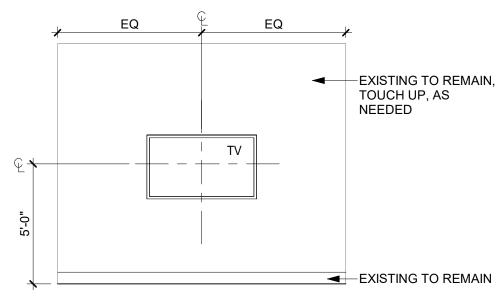

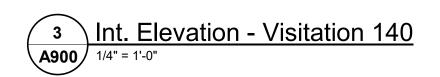

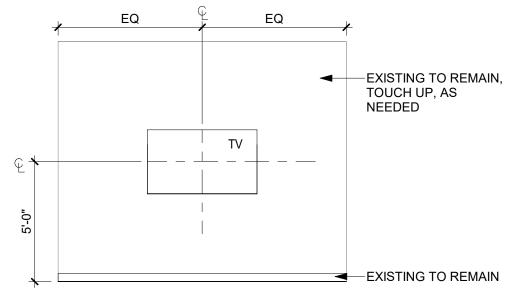

2 Int. Elevation - Conf./Board 143 A900 1/4" = 1'-0"

Sheet Title: Interior **Elevations** 

Client:

**DEPARTMENT OF** 

**HUMAN SERVICES** 

Project Number: 23122 Project Name:

COUNTY

Key Plan:

DHS ROCKDALE

975 SW Taylor Street, Conyers, GA 30012

Sheet Number: A900

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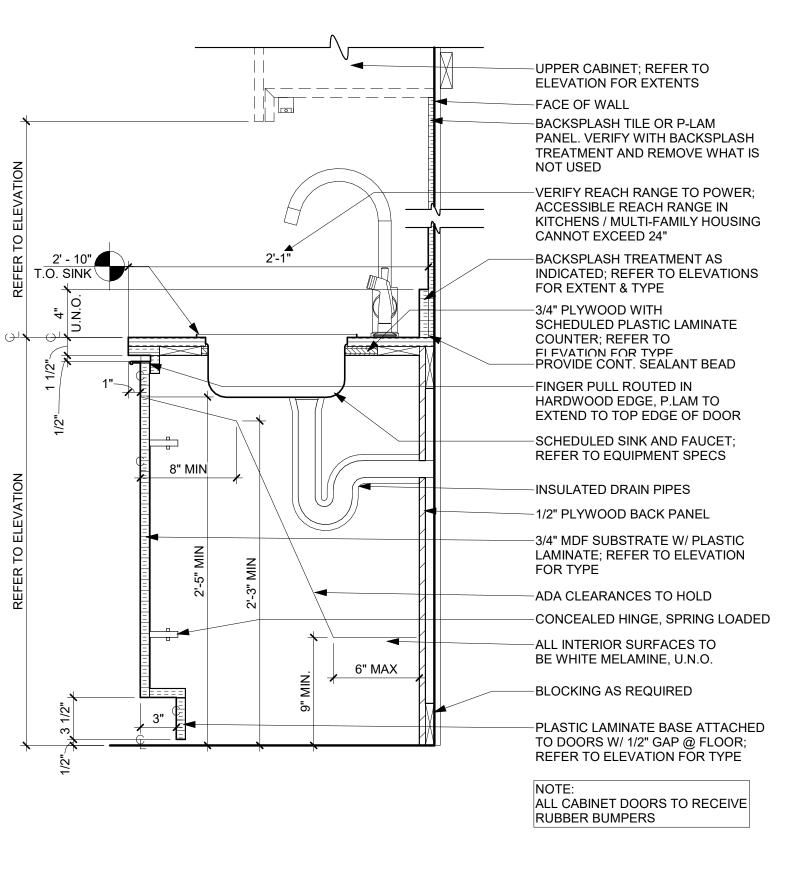
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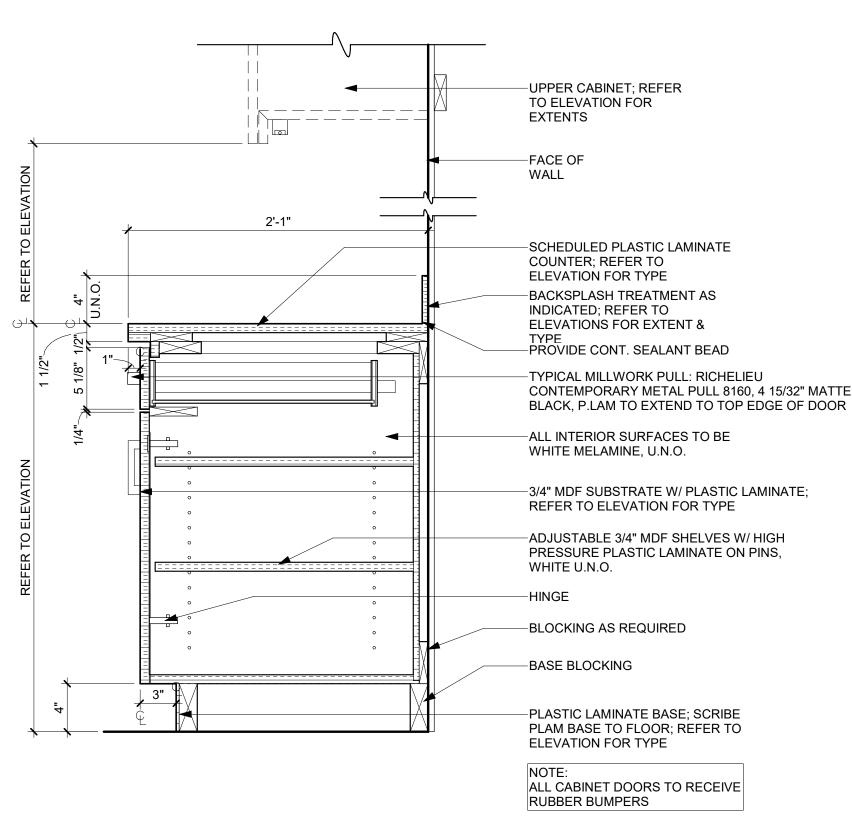
Comments


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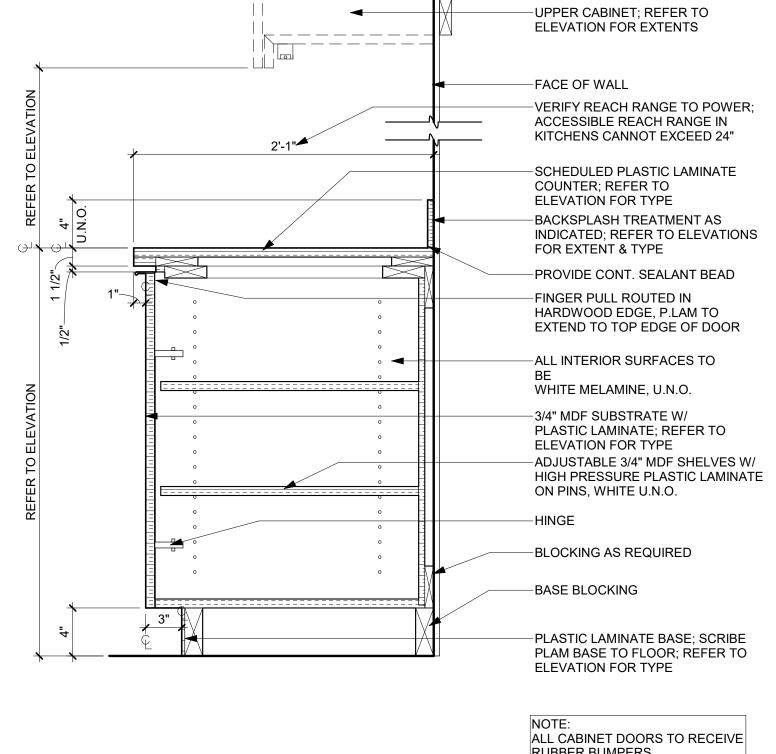
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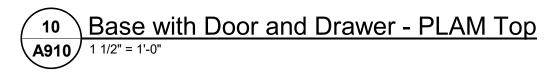







RUBBER BUMPERS

Base with Sink - PLAM Top
1 1/2" = 1'-0"

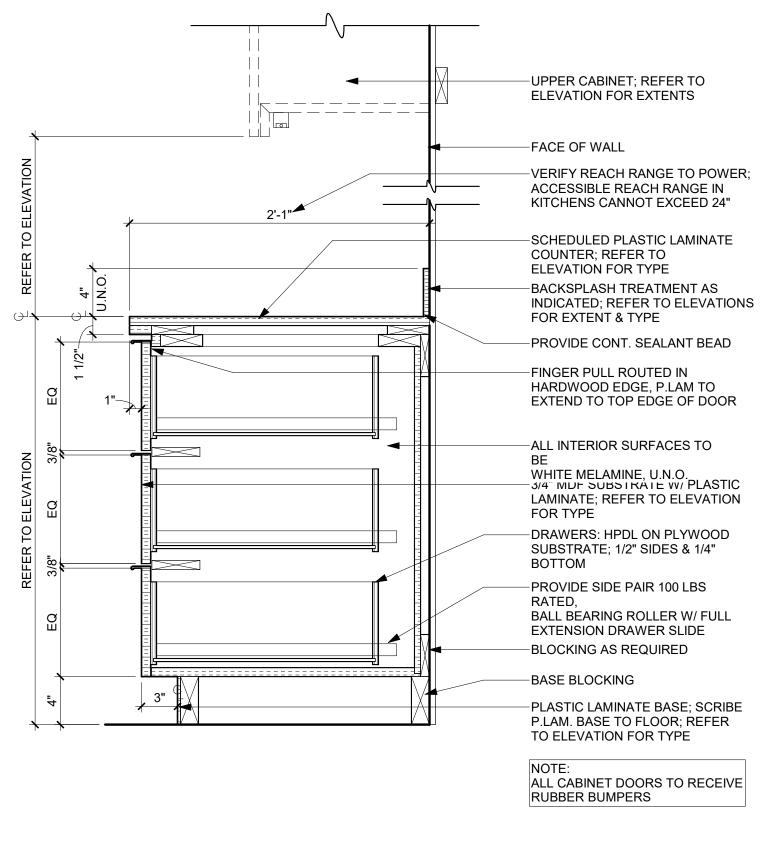

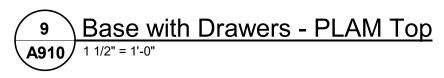

PL-1

P-1

PL-2

MP-1

SIDE PANELS





SIDE PANELS—

PL-1

P-1

PL-2

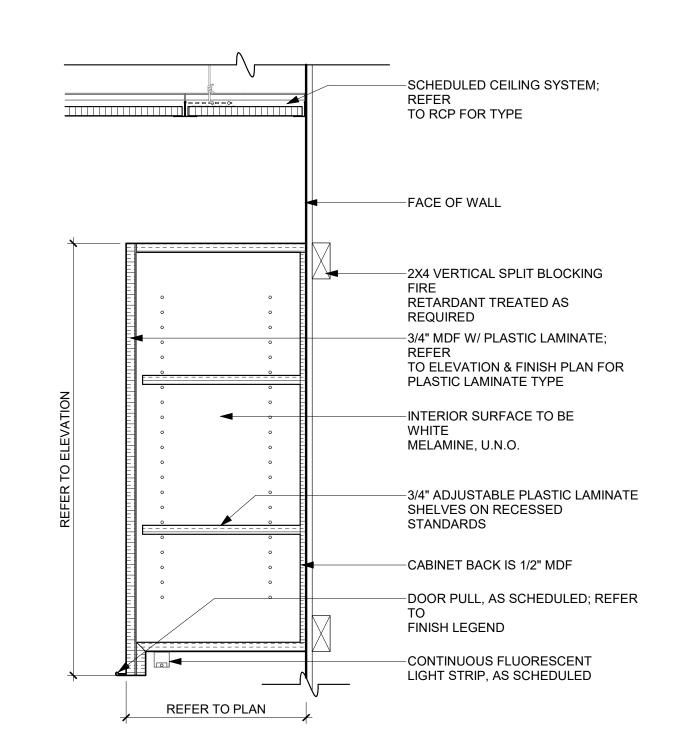

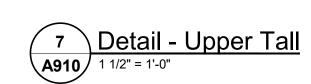

### **GENERAL MILLWORK NOTES**

EXTENT AS SHOWN. INTERIOR TO BE MELAMINE.

DELAMINATING SURFACES.

5. WHERE MILLWORK IS EXISTING TO REMAIN, UNITS ARE TO BE


FRONTS. REPAIR/REATTACH ANY EXISTING MILLWORK WITH

CABINETS WITH DOORS AND TWO (2) ADJUSTABLE SHELVES AND BASE CABINETS WITH DOORS AND ONE ADJUSTABLE SHELF, EXTENT AS SHOWN. PROVIDE ONE BANK OF DRAWERS 24" WIDTH AT BASE CABINET AREA. INTERIOR TO BE WHITE MELAMINE. 2. EACH BREAKROOM IS TO HAVE A FULLY ADA ACCESSIBLE SINK AREA, 34" HIGH × 36" MINIMUM WIDE. CABINET TO BE OPEN TO THE FLOOR BELOW WITH DOORS WITH APPLIED TOE-KICK. PROVIDE INSULATION ON P-TRAP 3. AT NEW MULTI-FIXTURE RESTROOMS, PROVIDE PLASTIC LAMINATE LAVATORY COUNTER WITH SET-IN SINKS. VANITY TO HAVE REMOVABLE PLASTIC LAMINATE PANEL TO SHIELD DRAINS. LAVATORY COUNTERS TO BE FULLY HANDICAP ACCESSIBLE AND IN COMPLIANCE WITH ALL ADA CLEARANCES. 4. AT COPY/FAX ROOMS PROVIDE PLASTIC LAMINATE CLAD BASE CABINETS AND UPPER CABINETS WITH DOORS AND ONE (1) ADJUSTABLE SHELF,


THOROUGHLY CLEANED. ALL MISSING OR MALFUNCTIONING HARDWARE


IS TO BE REPLACED. LEVEL AND REALIGN ALL DOORS AND DRAWER

1. AT EACH BREAK ROOM, PROVIDE PLASTIC LAMINATE CLAD UPPER

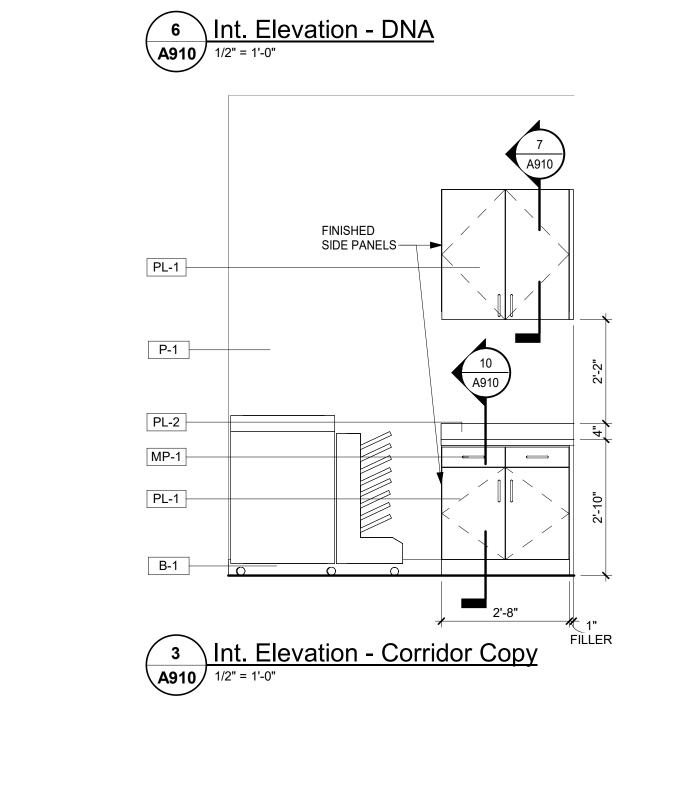

3'-0"

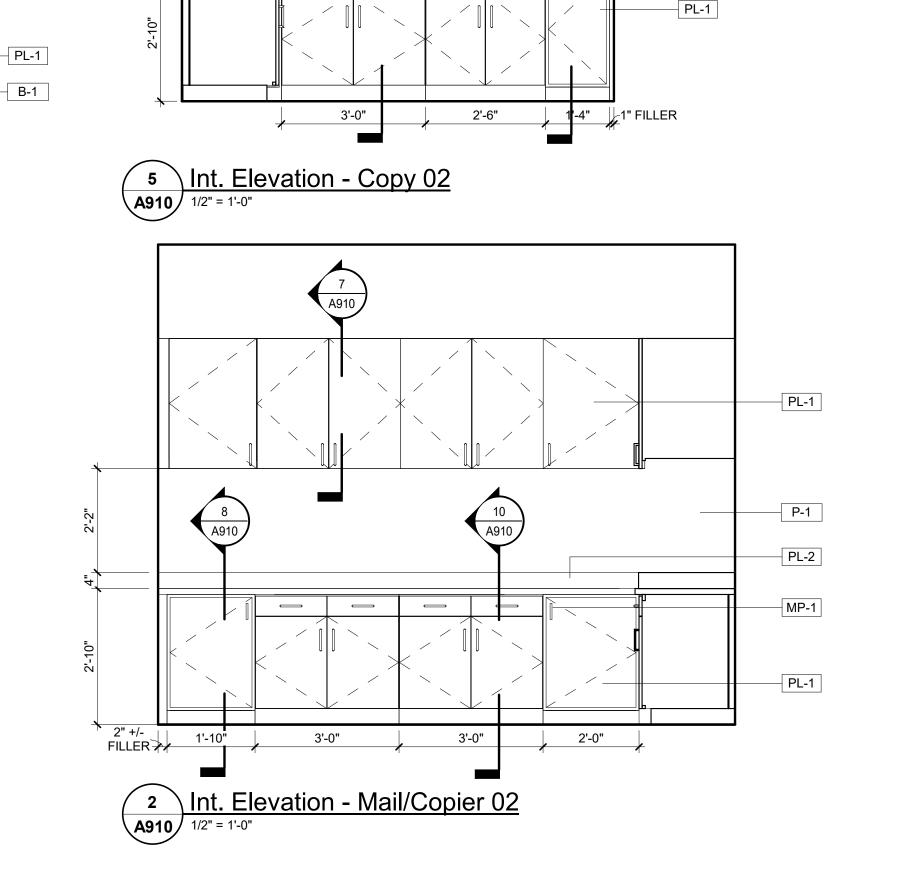

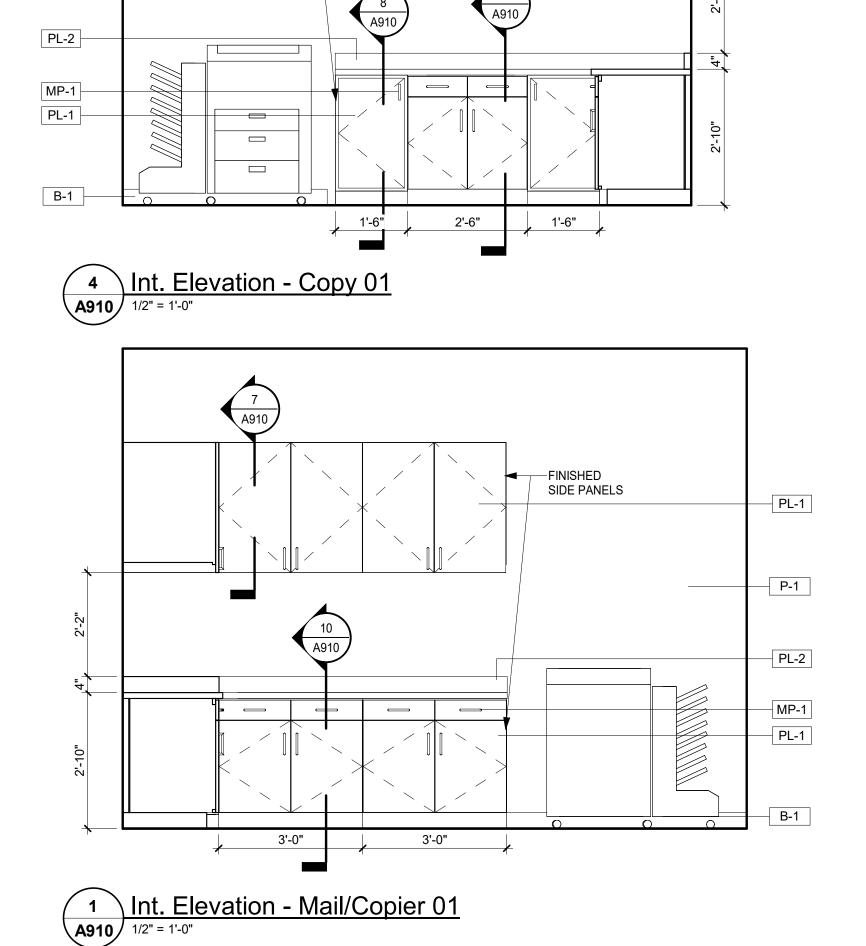



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BRIAN CHARLES TANNER

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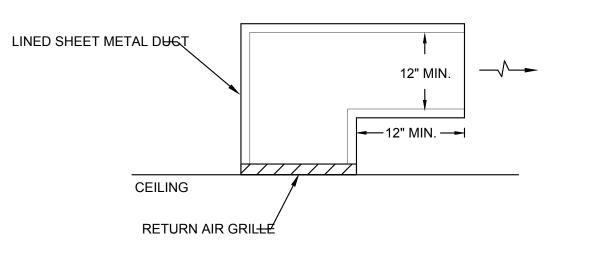
Project Number: 23122 Project Name: DHS ROCKDALE COUNTY

975 SW Taylor Street, Conyers, GA 30012

Key Plan:

Sheet Title: Millwork Elevations & **Details** 

Sheet Number:



M001 SCALE: N.T.S.

LEGEND

**ABOVE CEILING** 

BACKDRAFT DAMPER

EXISTING DUCT / PIPE

EXHAUST FAN

→ VERTICAL FIRE DAMPER

HORSEPOWER

MANUAL DAMPER

OUTSIDE AIR

RETURN AIR

SUPPLY AIR

SUPPLY REGISTER

RETURN AIR GRILLE

① THERMOSTAT

⋈ BALL VALVE

EXHAUST REGISTER

─**▼** FIRE DAMPER

ENTERING AIR TEMPERATURE

EXTERNAL STATIC PRESSURE

LEAVING AIR TEMPERATURE

MOTOR OPERATED DAMPER

WATER SOURCE HEAT PUMP

LEAVING WATER TEMPERATURE

→ VERTICAL COMBINATION FIRE & SMOKE DAMPER

ENTERING WATER TEMPERATURE

AIR HANDLER

**BELOW FLOOR** 

CEILING DIFFUSER

TAG SYMBOL DESCRIPTION

AHU

BDD

CD

CWS&R

CFM

DB

EXIST.

EAT

EWT

ER

RAG

WSHP

**GENERAL NOTES:** 

INSTALLED PER DETAIL 1/M0.1.

AS A PART OF THIS CONTRACT.

MORE THAN 50.

INSULATION.

1. ALL RETURN AIR AND TRANSFER AIR DUCTS SHALL BE LINED WITH 1" THICK DUCT LINER.

CONTRACTOR AND SHALL TIE INTO THE BASE BUILDING ENERGY MANAGEMENT SYSTEM.

ALL SUPPLY & OUTSIDE AIR DUCTWORK SHALL BE WRAPPED WITH R-6 FOIL BACKED

2. ALL RETURN AIR GRILLES, EXISTING AND NEW, SHALL HAVE RETURN AIR BOOTS

NEW CONTROL COMPONENTS SHALL BE OF THE SAME MANUFACTURER AS THE

EXISTING BUILDING SYSTEM, NO EXCEPTIONS. GRAPHICS SHALL BE UPDATED TO

4. ALL LOW VOLTAGE CONTROL WIRING SHALL BE INSTALLED AND WIRED TO EQUIPMENT

5. MATERIALS EXPOSED IN RETURN AIR PLENUMS SHALL BE NON COMBUSTIBLE WITH A

FLAME SPREAD INDEX NOT MORE THAN 25 AND A SMOKE DEVELOPED INDEX OF NOT

3. ALL CONTROL WORK SHALL BE COMPLETED BY A BASE BUILDING APPROVED

REFLECT ALL RELOCATED & NEW EQUIPMENT. ALL MATERIAL, LABOR AND

PROGRAMMING SHALL BE INCLUDED AS A PART OF THIS CONTRACT.

1 RETURN AIR GRILLE DETAIL

FLEX DUCT. SECURE FLEX

NYLON FLEX DUCT TIE,

SUPPLY AIR DUCT

DUCT TO DIFFUSER NECK & BRANCH DUCT WITH

200 Galleria Parkway Suite 1150 Atlanta, GA 30339 404-965-1287 tel


WE # 23289

BRANCH DUCT & FLEX DUCT SIZE SHALL MATCH DIFFUSER

NECK SIZE OR SIZE NOTED ON PLAN, WHICHEVER IS LARGER.

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Suite 1450 404-875-4500 tel Atlanta, GA 30303 www.praxis3.com

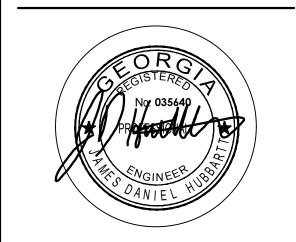


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DURO DYNE DYN-O-TIE ROUND SHEET METAL BRANCH DUCT - 8' MAX ----MANUFACTURED SPIN-IN FITTING WITH SCOOP & LOCKING DAMPER.

#### CONDENSER WATER SUPPLY & RETURN CUBIC FOOT PER MIN. **DIFFUSER CONNECTION DETAIL** DRY BULB M001 SCALE: N.T.S. NEW DUCT WORK



FAN SCHEDULE										
TAG	AIRFLOW	ESP	MOTOR	FAN	DRIVE	VOLTS/	NOISE	TYPE	BASIS OF DESIGN	NOTES
IAG	(CFM)	(IN W.C.)	W	RPM	TYPE	PHASE	(SONES)		BASIS OF BESIGN	NOTES
EF-A	75	0.5	17	773	DIRECT	120/1	3	CEILING	GREENHECK SP-LP0511-1	1,2
EF-B	100	0.5	12	960	DIRECT	120/1	2.5	CEILING	GREENHECK SP-A90-130-VG	1,3
OTEO	<u> </u>	-	-						·	

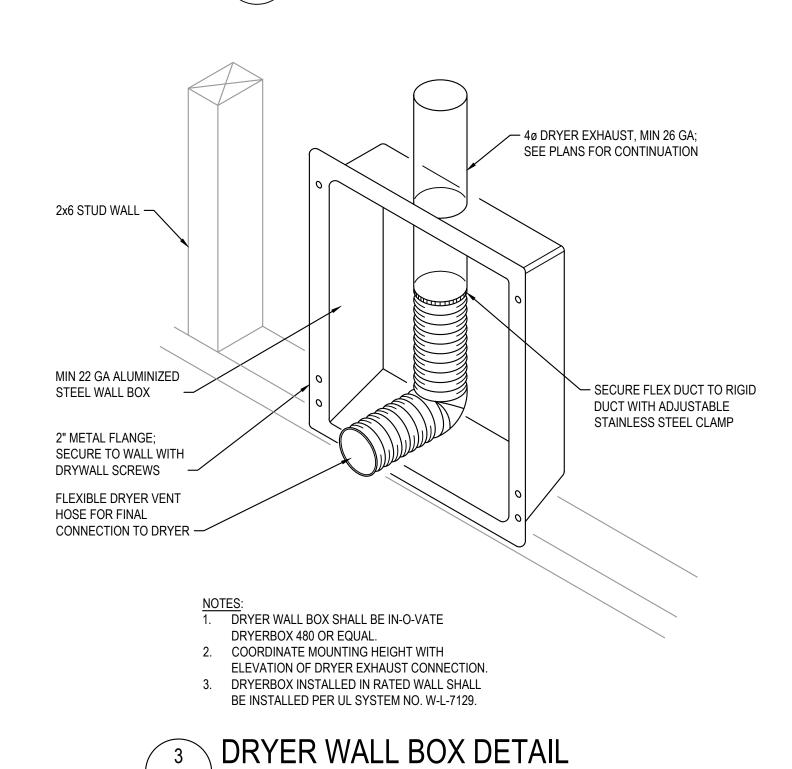M001 SCALE: N.T.S.

1. PROVIDE WITH BACKDRAFT DAMPER AND SPEED CONTROLLER FOR BALANCING.

2. FAN SHALL BE INTERLOCKED WITH LIGHTS. 3. FAN SHALL OPERATE CONTINUOUSLY.

	AIR DISTRIBUTION SCHEDULE	
TAG	DESCRIPTION	BASIS OF DESIGN
	CEILING SUPPLY DIFFUSERS (CD) SHALL BE STEEL PERFORATED DIFFUSER WITH 4-WAY FACE	
CD	DEFLECTORS. FACE AREA SHALL BE SUITABLE FOR 24"X24" LAY-IN CEILING GRID. PROVIDE WITH BAKED	TITUS PAS
	ENAMEL FINISH IN A COLOR MATCHING THE CEILING GRID.	
	CEILING RETURN GRILLES (RAG) SHALL BE STEEL PERFORATED FACE TO MATCH SUPPLY DIFFUSERS. FACE	
RAG	AREA SHALL BE SUITABLE FOR 24"X24" LAY-IN CEILING GRID. PROVIDE WITH BAKED ENAMEL FINISH IN A	TITUS PAR
	COLOR MATCHING THE CEILING GRID.	

**DEPARTMENT OF HEALTH SERVICES** 

Project Number: 23122

Project Name: DHS ROCKDALE COUNTY

975 SW Taylor Street, Conyers, GA

Key Plan:

Sheet Title:

Legends, Notes, Details, and Schedules


Sheet Number:

M001



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Rev Date Comments 02.23.2024 Issue for Permit

GENERAL NOTES: 1. FIELD VERIFY EXISTING CONDITIONS.

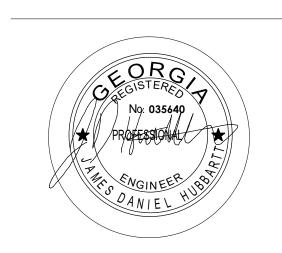CONNECT NEW DIFFUSER TO EXISTING DUCTWORK. FIELD COORDINATE DUCT ROUTING. 2 DUCT NEW RETURN GRILLE TO EXISTING RETURN DUCT. FIELD COORDINATE DUCT ROUTING.

**KEYNOTES** 

ROUTE DRYER EXHAUST DUCT UP TO ROOF HOOD. BASIS OF DESIGN DRYER JACK. 4 8"Ø DUCT UP TO ROOF HOOD. BASIS OF DESIGN GREENHECK GRSR. 5 DIFFUSER IS EXISTING TO REMAIN. BALANCE DIFFUSER AS SHOWN.

6 RETURN GRILLE IS EXISTING TO REMAIN. FIELD VERIFY EXACT LOCATION. 7 BREAKROOM IS EXISTING TO REMAIN. FIELD VERIFY EXSTING CONDITIONS.

8 DEMO EXISTING DIFFUSERS AND ASSOCIATED DUCT TAPS.

9 COPY ROOM IS EXISTING TO REMAIN. FIELD VERIFY EXSTING CONDITIONS.



1 LEVEL 1 HVAC PLAN M101 1/8" = 1'-0"

**DEPARTMENT OF HEALTH SERVICES** 

Project Number: 23122 Project Name:

DHS ROCKDALE COUNTY

975 SW Taylor Street, Conyers, GA 30012

Key Plan:

Sheet Title:


MECHANICAL **PLAN** 

Sheet Number:

M101

200 Galleria Parkway Suite 1150 Atlanta, GA 30339 404-601-9859 fax cesslinger@westside-engineering.com **VE # 23289** 

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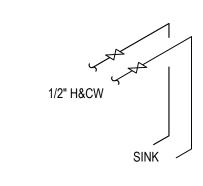

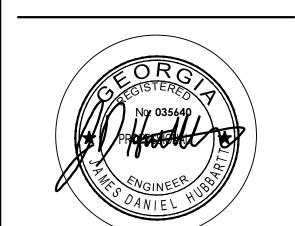
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Rev	Date	Comments
	02.23.2024	Issue for Permit

1/2" TRAP PRIMER — TRAP PRIMER DISTRIBUTION / 1/2" TRAP PRIMER LINE TO FLOOR DRAIN

2 TRAP PRIMER DETAIL
P001 SCALE: N.T.S.



4 TYP. SINGLE SINK - DOMESTIC WATER RISER P001 SCALE: N.T.S.

	CLAMPING COLLAR IN LOW POSITION	ADJUSTABLE STRAINER —		CLAMPING COLLAR IN HIGH POSITION
2" TRAP	M			FINISHED FLOOR
RIMER LINE	: - 4			WATER PROOFING MEMBRANE
				STRUCTURAL SLAB
				CAST IRON DRAIN BODY
	TRAP PRIMER CONNECTION —		RUBBER GA	
	CONTRACTION			

GENERAL NOTES (APPLY TO ALL SHEETS):

2. ALL SANITARY PIPING SHALL BE SLOPED AT 1/8" PER FOOT.

TAG SYMBOL DESCRIPTION

A/C

AFF

B/F

B/G

EXIST.

FCU

FDC

FS

FW

HD

HWR

VTR

wco

WSHP

FCO

1. REFER TO ARCHITECTURAL DRAWINGS FOR EXACT FIXTURE MOUNTING HEIGHTS & LOCATIONS.

2. COORDINATE ALL SAN, VENT, CW, HW, ETC. WITH EXISTING CONDITIONS & ALL OTHER TRADES.

3. ALL PIPING SHALL BE PRESSURE TESTED PRIOR TO CONCEALING OR INSULATING THE PIPING.

NOT MORE THAN 25 AND A SMOKE DEVELOPED INDEX OF NOT MORE THAN 50.

LEGEND

ABOVE FINISHED FLOOR

EXISTING PIPE / EQUIPMENT

FIRE DEPARTMENT CONNECTION

AIR HANDLING UNIT

BELOW FLOOR

BELOW GRADE

——— DOMESTIC COLD WATER

FAN COIL UNIT

FLOOR SINK

HOSE BIBB

FILTERED WATER

DOMESTIC HOT WATER

HOT WATER RETURN

VENT THROUGH ROOF

WATER SOURCE HEAT PUMP

WALL CLEAN OUT WASTE PIPING

SANITARY PIPING

STORM PIPING

VENT PIPING

FLOOR CLEAN OUT

I CLEAN OUT

↑ CHECK VALVE

----- NEW WORK

——⇒⊠ FLOOR DRAIN


——⇒⊙ HUB DRAIN

NFWH NON FREEZE WALL HYDRANT

ABOVE CEILING

4. MATERIALS EXPOSED IN RETURN AIR PLENUMS SHALL BE NON COMBUSTIBLE WITH A FLAME SPREAD INDEX



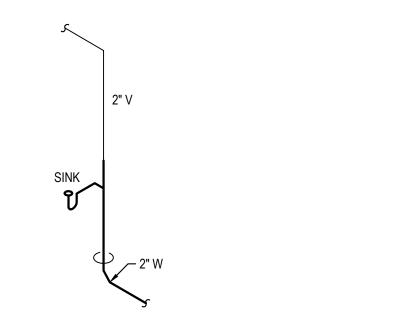

TYP. SINGLE SINK - SAN & VENT RISER P001 SCALE: N.T.S.

PLUMBING FIXTURES & CONNECTION SCHEDULE										
TAG	FIXTURE	CW	HW	WASTE	VENT	FIXTURE SPECIFICATION				
<u>P-1H</u>	ADA WATER CLOSET	3/4"		4"	2"	ADA COMPLIANT, WHITE VITREOUS CHINA, FLOOR MOUNT, ELONGATED, 16-1/2" HIGH BOWL WITH LOCKING TANK COVER, 1.1 GPF PRESSURE ASSIST FLUSH, AND SOLID PLASTIC OPEN FRONT SEAT. BASIS OF DESIGN: AMERICAN STANDARD 2467.100.020 BOWL AND 5055A.65C SEAT. REFER AND COORDINATE WITH ARCHITECTURAL SHEET A810.				
<u>P-2H</u>	LAVATORY - WALL HUNG	1/2"	1/2"	2"	2"	ADA COMPLIANT, WHITE VITREOUS CHINA, WALL MOUNTED LAVATORY WITH GRID STRAINER, TAIL PIECE, OFFSET P-TRAP, SERVICE STOPS, ADA INSULATION KIT, 1.2 GPM, SOLID BRASS. AMERICAN STANDARD "LUCERNE" WITH FAUCET HOLES ON 4" CENTERS SINK AND AMERICAN STANDARD "PRINCETON" WITH LEVER HANDLES AND POP-UP DRAIN FAUCET. REFER AND COORDINATE WITH ARCHITECTURAL SHEET A810.				
<u>P-3</u>	MOP SINK	3/4"	3/4"	3"	2"	24"x24" TERRAZO FLOOR MOUNTED MOP SINK WITH FULL PERIMETER STAINLEES STEEL CAP, 3" CAULKED DRAIN CONNECTION, STAINLESS STEEL GRID STRAINER, 36X36 STAINLESS STEEL WALL PANELS ON ALL ADJACENT WALLS, 36"LONG HOSE, HOSE HOOK SERVICE SINK FAUCET WITH BUCKET HOOK AND 3/4" HOSE CONNECTION. BASIS OF DESIGN: STERN WILLIAMS - SB900 SINK AND STERN WILLIAMS T-10-VB FAUCET.				
<u>P-4</u>	DRINKING FOUNTAIN	1/2"		2"	2"	ADA COMPLIANT,ELKAY ENHANCED EZH20 BOTTLE FILLING STATION & VERSATILE BI-LEVEL ADA COOLER FILTERED REFRIGERATED LIGHT GRAY. CHILLING CAPACITY OF 8.0 GPH OF 50 DEGREE F DRINKING WATEE, BASED ON 80 DEGREE F INLET WATER AND 90 DEGREE F AMBIENT. BASIS OF DESIGN: ELKAY LZSTL8WSLP DRINKING FOUNTAIN.				
<u>P-5</u>	SINK	1/2"	1/2"	2"	2"	ADA COMPLIANT, UNDERMOUNT, 18 GA STAINLESS STEEL WITH 21"x15-3/4"x7-1/2" DEEP BOWL DIMENSIONS, SOUND DAMPENING UNDER COATING, 1.8 GPM, FINISH: MATTE BLACK FAUCET, SINGLE HANDLE AND 9-1/2" GOOSE NECK SWING SPOUT, BASKET STRAINER, TAIL PIECE, OFFSET P-TRAP, SERVICE STOPS & ADA INSULATION KIT. BASIS OF DESIGN: ELKAY ELUH2115 SINK AND DELTA 9159-BL-DST FAUCET.				
<u>P-6</u>	WASHER BOX	1/2"	1/2"	2"	2"	METAL WASHER BOX WITH SOLID BRASS, 1/4 TURN BALL VALVES. BAIS OF DESIGN IS OATEY 38981				
<u>P-7</u>	ADA BATH/SHOWER	1/2"	1/2"	2"	2"	30" X 60" SOLID ACRYLIC TUB WITH OVERFLOW AND DRAIN ASSEMBLY, 1.5 GPM HANDHELD SHOWER HEAD, 59" HOSE, 25" SLIDE BAR & VALVE. VALVE SHALL PRESSURE BALANCING, ANTI SCALD TYPE WITH HOT LIMIT SAFETY STOP AND TUB SPOUT AND DIVERTER VALVE. BASIS OF DESIGN: AMERICAN STANDARD "OVATION" 2647 TUB, AMERICAN STANDARD "COLONY" 1662.610 HEAD SET AND VALVE.				
ED	FLOOR DRAIN - FINISHED	4/0" TD		211	2"	FLOOR DRAINS IN FINISHED AREAS SHALL HAVE 6" SQUARE ADJUSTABLE, VANDAL PROOF				

# DEPARTMENT OF **HEALTH SERVICES**

Template Address

Project Number: 23122 Project Name:

DHS ROCKDALE COUNTY

Conyers, GA

Key Plan:

LEGEND, NOTES,
DETAILS, AND
SCHEDULES PLUMBING

Sheet Number:


P001





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### **KEYNOTES**

- 1 EXISTING PLUMBING FIXTURE TO REMAIN.
- 2 2" W, 2" V. CONNECT NEW 2" W AND 2" V LINES TO EXISTING WASTE AND VENT LINES BELOW FLOOR AND ABOVE CEILING. FIELD VERIFY EXACT EXISTING LINES LOCATION AND FLOW DIRECTION PRIOR FINAL CONNECTION. 4 4" W, 2" V.
- CONNECT NEW 4" SAN AND 2" V LINES TO EXISTING SAN AND VENT LINES BELOW FLOOR AND ABOVE CEILING. FIELD VERIFY EXACT EXISTING LINES LOCATION AND FLOW DIRECTION PRIOR FINAL CONNECTION.
- 6 3" W, 2" V. CONNECT NEW 3" W AND 2" V LINES TO EXISTING WASTE AND VENT LINES BELOW FLOOR AND ABOVE CEILING. FIELD VERIFY EXACT EXISTING LINES LOCATION AND FLOW DIRECTION PRIOR FINAL CONNECTION.

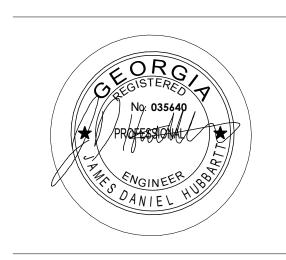**DEPARTMENT OF HEALTH SERVICES** 

Project Number: 23122 Project Name:

DHS ROCKDALE COUNTY

975 SW Taylor Street, Conyers, GA

Key Plan:

**PLUMBING** PLAN - SAN & **VENT** 

Sheet Number:

P101

1 PLUMBING FLOOR PLAN - SAN & VENT P101 1/8" = 1'-0"






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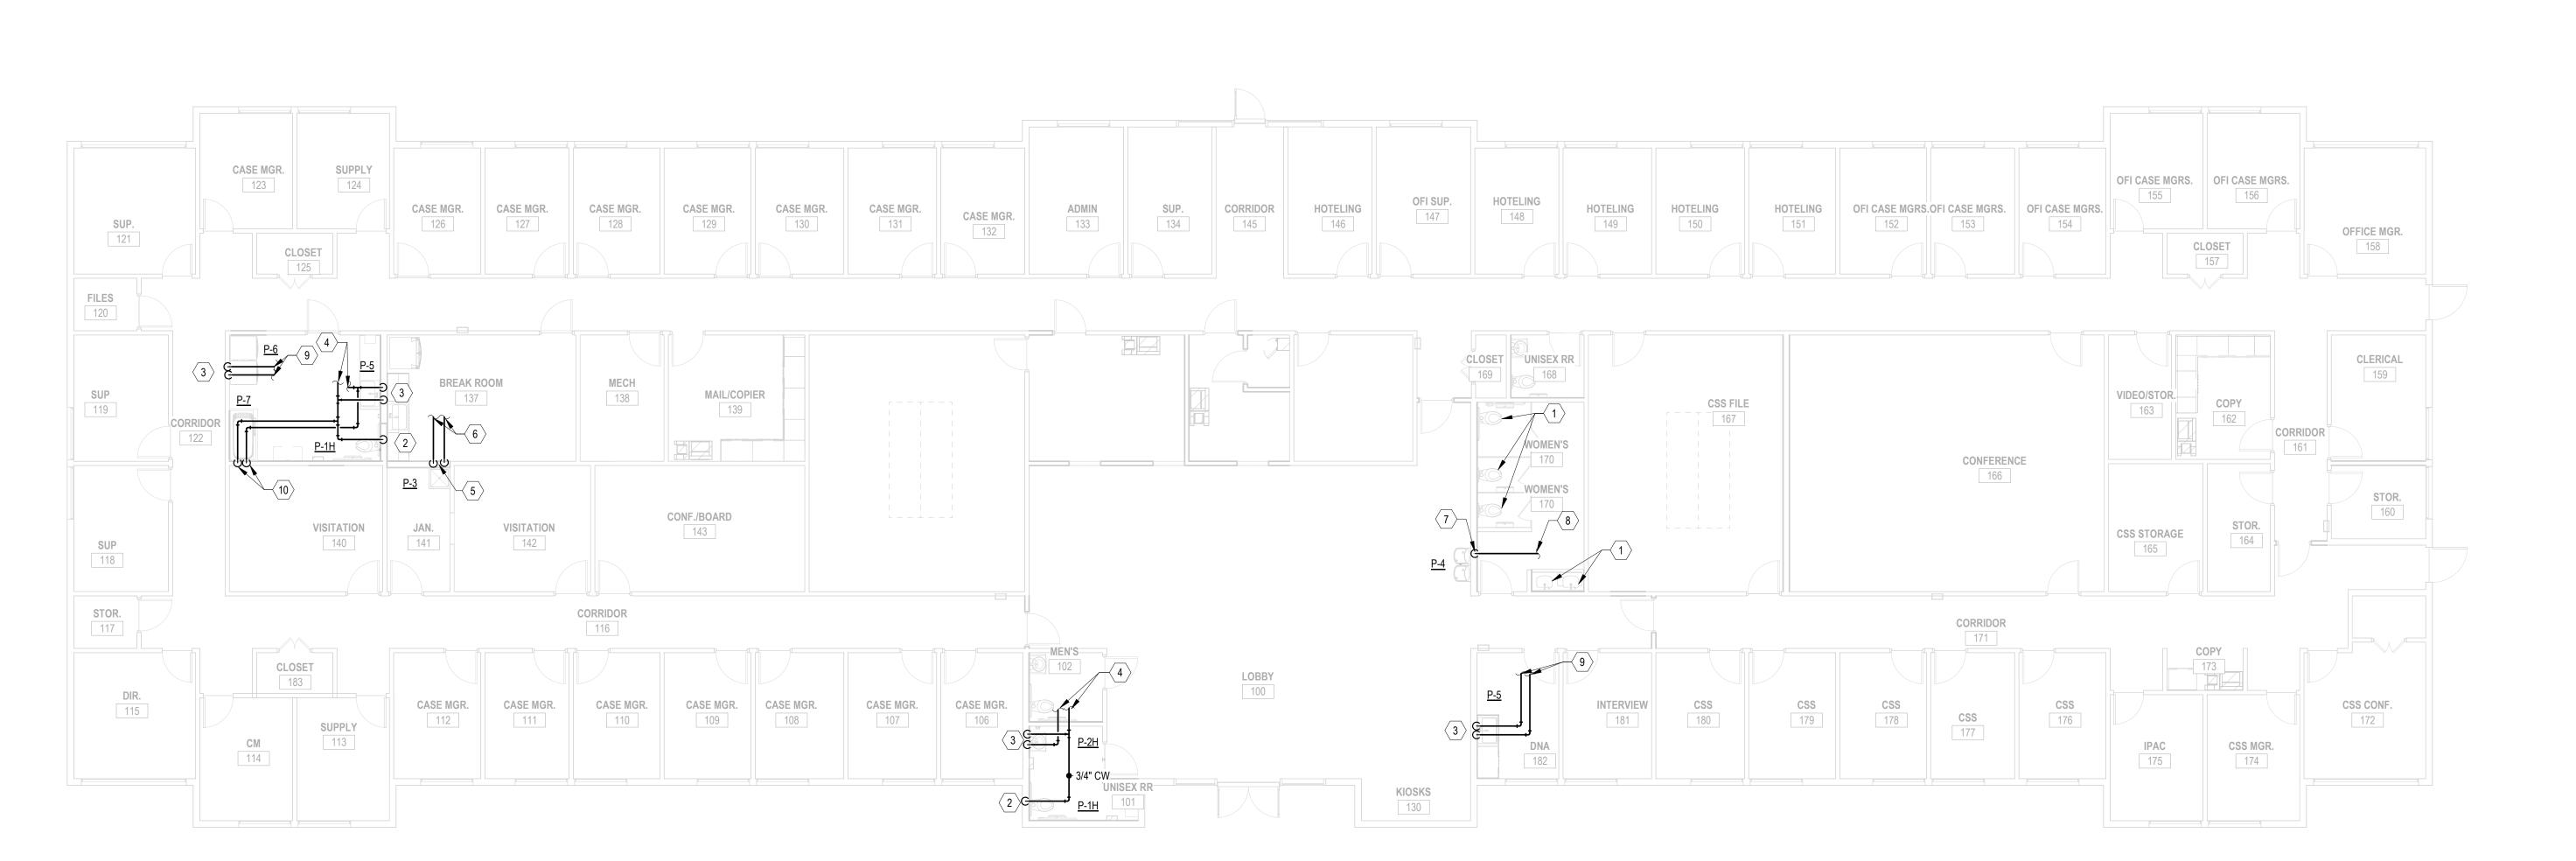
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#### **KEYNOTES**

- EXISTING PLUMBING FIXTURE TO REMAIN.
- NEW 3/4" CW DN TO CONNECT TO NEW PLUMBING FIXTURE. FIELD VERIFY EXACT LOCATION.
- NEW 1 /2" H&CW DN TO CONNECT TO NEW PLUMBING FIXTURE. FIELD VERIFY EXACT LOCATION. CONNECT NEW 3/4" CW AND 3/4" HW TO EXISTING COLD AND HOT WATER LINES ON ABOVE CEILING. FIELD VERIFY EXACT LOCATION OF EXISTING WATER LINES AND
- NEW 3/4" H&CW DN TO CONNECT TO NEW PLUMBING FIXTURE.
- CONNECT NEW 3/4" H&CW TO EXISTING COLD AND HOT WATER LINES ABOVE
- CEILING. FIELD VERIFY EXACT OF EXISTING LINES LOCATION.
- NEW 1/2" CW DN TO CONNECT DRINKING FOUNTAIN. 8 CONNECT NEW 1/2" CW TO EXISTING COLD WATER LINE ABOVE CEILING. FIELD
- CONNECT NEW 1/2" H&CW TO EXISTING COLD AND HOT WATER LINES ABOVE CEILING. FIELD VERIFY EXACT OF EXISTING LINES LOCATION.
- VERIFY EXACT OF EXISTING LINE LOCATION. 10 NEW 1/2" H&CW DN TO MIXING VALVE AND ROUTE TO CONNECT TO SHOWER FAUCET AND OR SHOWER HEAD. FIELD VERIFY EXACT LOCATION.

**DEPARTMENT OF HEALTH SERVICES** 

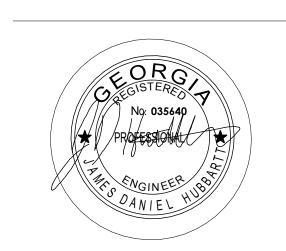Project Number: 23122 Project Name:

DHS ROCKDALE **COUNTY** 

975 SW Taylor Street, Conyers, GA

Key Plan:

**PLUMBING** PLAN - DOM WATER


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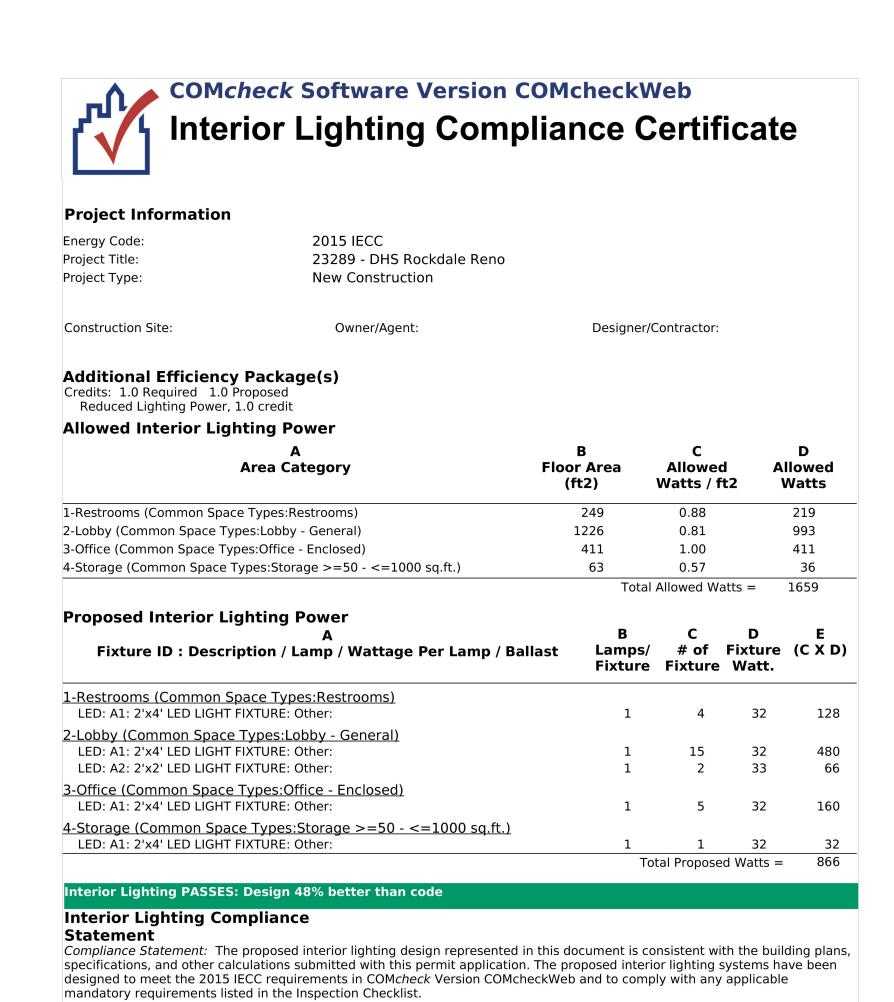
P201

1 PLUMBING FLOOR PLAN - DOM WATER
1/8" = 1'-0"

	LIGHTING FIXTURE SCHEDULE											
TYPE	PE DESCRIPTION		VOLTAGE	LAMP QTY	LAMP WATTAGE/ MANUFACTUREF TYPE		CATALOG NUMBER	NOTES				
<b>A</b> 1	2'X4' INDIRECT NARROW LENS LED FIXTURE, 4000 LUMENS	RECESSED	120/277	-	32W LED 3500K	LITHONIA LIGHTING	2BLT4-40L-ADSM-GZ10-LP835	1				
<b>A</b> 2	2'X2' INDIRECT NARROW LENS LED FIXTURE, 3900 LUMENS	RECESSED	120/277	-	33W LED 3500K	LITHONIA LIGHTING	2BLT2-40L-ADSM-GZ10-LP835	1				
	EDGELIT EXIT SIGN, SINGLE FACE, RED LETTERING, PROVIDE WITH ARROW(S) AS SHOWN WITH INTEGRAL BATTERY BACK-UP	CEILING/ WALL	120/277		FURN WITH UNIT	LITHONIA LIGHTING	EDG-1-R-EL					

PROVIDE WITH 90-MINUTE BATTERY BACKUP WHERE INDICATED ON DRAWINGS. LINEAR FIXTURES SHALL HAVE 600 LUMEN INVERTER. DOWNLIGHTS SHALL HAVE INTEGRAL TEST SWITCH.



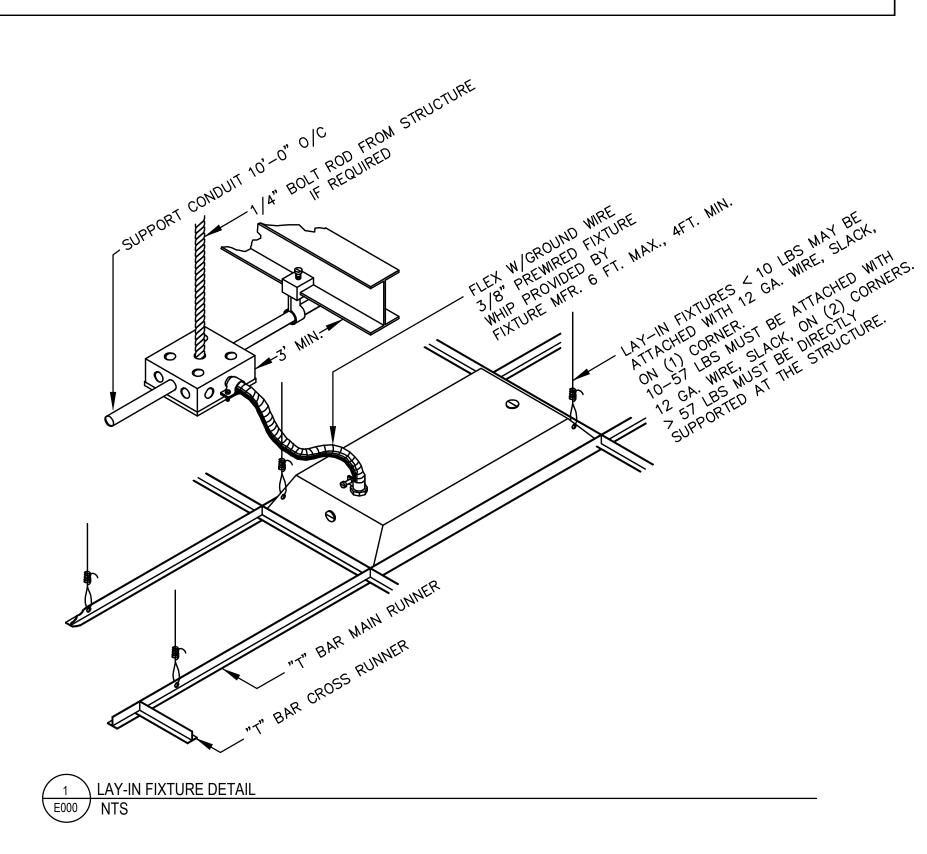

Report date: 12/19/23

Page 1 of 5

Project Title: 23289 - DHS Rockdale Reno

Data filename:

#### GENERAL ELECTRICAL NOTES:

- 1. FOR EXACT LOCATION OF EQUIPMENT MOUNTED IN SUSPENDED CEILINGS. SUCH AS LIGHTING FIXTURES, AND SMOKE DETECTORS, SEE ARCHITECTURAL REFLECTED CEILING PLANS. ARCHITECTURAL REFLECTED PLAN SHALL
- 2. PRIOR TO ROUGH-IN, CONTRACTOR SHALL COORDINATE EXACT LOCATION OF ALL WIRING DEVICE WITH ARCHITECTURAL ELEVATION TO AVOID CONFLICTS WITH CASEWORK, COUNTER TOPS, DOOR SWINGS, ETC. WHERE CONFLICTS OCCURS, CONTRACTOR SHALL CONTACT THE ARCHITECT IN WRITING FOR RESOLUTION.
- 3. ALL MOUNTING HEIGHT DIMENSIONS ARE TO THE CENTER OF THE OUTLET BOX UNLESS OTHERWISE NOTED.
- 4. FOR EXACT LOCATION OF ALL EXTERIOR LIGHTING FIXTURES MOUNTED ON EXTERIOR OF BUILDING, ARCHITECTURAL ELEVATIONS SHALL GOVERN
- 6. THE CONTRACTOR SHALL USE CARE WHEN CUTTING OPENINGS FOR OUTLET BOXES IN CMU WALLS. OUTLET BOXES SHALL BE INSTALLED IN CMU WALLS SECURELY WITH EPOXY.

5. PRIOR TO ROUGH-IN FOR ALL LIGHTING SWITCHES, VERIFY ALL DOOR SWINGS WITH ARCHITECTURAL PLANS.

- 7. THE CONTRACTOR IS RESPONSIBLE FOR COORDINATING OUTLET BOX INSTALLATION WITH WALL FINISH (GYPSUM FURRING, TILE, ETC). THE CONTRACTOR SHALL PROVIDE AND INSTALL ANY EXTENSION RINGS NECESSARY TO
- ACCOMMODATE WALL FINISHES. 8. ALIGN VERTICALLY AND HORIZONTALLY ALL LIGHT SWITCHES, THERMOSTATS, FIRE ALARM PULL STATIONS, ETC.
- ALL THESE ITEMS SHALL BE CLUSTERED WHERE POSSIBLE. COORDINATE EXACT REQUIREMENTS WITH ARCHITECT. 9. COORDINATE MOUNTING OF ALL EXTERIOR DISCONNECT WITH ARCHITECTURAL ELEVATIONS. IF NOT INDICATED ON ARCHITECTURAL ELEVATIONS, REQUEST ELEVATIONS OF DISCONNECT SWITCHES FROM ARCHITECT IN WRITING
- 10. ALL CONDUITS FOR LOW VOLTAGE OUTLETS SHALL BE DEDICATED TO A SINGLE BOX. NO DAISY CHAINING OR SHARING OF CONDUITS BETWEEN LOW VOLTAGE OUTLET BOXES IS PERMITTED UNLESS SPECIFICALLY INDICATED ON THE DRAWINGS.
- 11. PROVIDE FIELD IDENTIFICATION FOR PANELBOARDS AND SWTCHBOARDS (IF APPLICABLE) PER NEC 408.4. ADDITIONALLY, EACH RECEPTACLE AND DISCONNECT SHALL HAVE A PRINTED LABEL WITH SPECIFIC PANEL AND CIRCUIT NUMBER.
- 12. PROVIDE PERMANENT NAMEPLATE LABEL FOR PANELBOARDS IDENTIFYING COLOR CODING FOR BRANCH CIRCUITS, IN ACCORDANCE WITH NEC 210.5(C)(1).
- 13. PER NEC 406.12 PROVIDE TAMPER PROOF RECEPTACLES IN THE FOLLOWING AREAS: DWELLING UNITS, COMMON AREAS OF MULTIFAMILY DWELLINGS, GUEST ROOMS AND COMMON AREAS OF MOTELS/HOTELS, CHILDCARE FACILITIES, PRESCHOOLS AND EDUCATIONAL FACILITIES, DORMITORY UNITS, ASSISTED LIVING FACILITIES AND ASSEMBLY OCCUPANCIES PER SECTION 518.2. TAMPER PROOF RECEPTACLES ARE ALSO REQUIRED IN BUSINESS OFFICES, CORRIDORS AND WAITING ROOMS WITHIN CLINICS/MEDICAL OFFICES/DENTAL OFFICES/OUTPATIENT FACILITIES.

#### GENERAL ELECTRICAL DEMOLITION NOTES

PRIOR TO ROUGH-IN.

- 1. ELECTRICAL CONTRACTOR SHALL REMOVE DEVICES ON WALLS TO BE REMOVED AND AS DIRECTED BY ARCHITECT.
- ELECTRICAL CONTRACTOR SHALL REMOVE ALL ASSOCIATED WIRING, CONDUIT, SURFACE RACEWAY, ETC. FOR DEVICES/LOADS BEING REMOVED. ITEMS REMOVED SHALL BECOME PROPERTY OF THE ELECTRICAL CONTRACTOR (UON) AND SHALL BE REMOVED FROM THE SITE. ITEMS REMOVED SHALL NOT BE STORED AT THE SITE. UNDER NO CONDITIONS SHALL ITEMS REMOVED BE USED IN THE NEW CONSTRUCTION.
- 3. ELECTRICAL CONTRACTOR SHALL VISIT AND EXAMINE THE SITE PRIOR TO CONSTRUCTION TO ASCERTAIN THE EXISTING CONDITIONS AND LIMITS OF DEMOLITION AND CONSTRUCTION.
- 4. IT SHALL BE THE ELECTRICAL CONTRACTORS RESPONSIBILITY TO PROTECT AND RETAIN POWER TO ALL EXISTING ACTIVE EQUIPMENT TO REMAIN. THIS INCLUDES RE-ROUTING OF EXISTING CIRCUITING EFFECTED BY
- 5. ALL REMOVED COMPUTER EQUIPMENT SHALL BE TURNED OVER TO OWNER UNLESS DIRECTED TO DO
- 6. SEE MECHANICAL DRAWING FOR HEATERS, EXHAUST FANS, ETC., WHICH MUST BE DISCONNECTED BY THE ELECTRICAL CONTRACTOR FOR REMOVAL OR ABANDONMENT BY MECHANICAL CONTRACTOR. ELECTRICAL
- CONTRACTOR SHALL REMOVE ALL STARTERS, DISCONNECT SWITCHES AND ASSOCIATED CONDUIT AND WIRING.
- REMOVE ALL CONDUIT, WIRE, BOXES AND FASTENING DEVICES AS REQUIRED TO AVOID ANY INTERFERENCE WITH NEW INSTALLATION. CONDUITS MAY BE ABANDONED IN FLOOR AND WALLS ONLY. ELECTRICAL CONTRACTOR SHALL REMOVE ALL
- WIRING FROM ABANDONED CONDUITS. DISCONNECT FROM ALL POWER SOURCES AND PROVIDE BLANK PLATES ON ALL ABANDONED OUTLETS. CUT OFF ABANDONED CONDUITS 1" BELOW FINISHED FLOOR AND GROUT FLUSH. ABANDONED CONDUIT SHALL BE CAPPED AT BOTH ENDS.
- 9. ELECTRICAL CONTRACTOR SHALL TRACE ALL CIRCUITS IN EXISTING PANELS TO REMAIN AFFECTED BY DEMOLITION. TURN OFF AND TAG ALL UNUSED CIRCUIT BREAKERS AS AND LABEL AS "SPARE" AND TIGHTEN ALL CONNECTIONS. PROVIDE NEW TYPED DIRECTORY WITH DATE, PROTECTED BY PLASTIC AND PLACE IN COVER OF PANELS CONSISTENT WITH NEW CONSTRUCTION.
- 10. ANY ELECTRICAL OUTAGES REQUIRED BY THE WORK SHALL BE COORDINATED WITH OWNER'S REPRESENTATIVE AND CONFIRMED IN WRITING. ANY OUTAGE SHALL NOT BE SCHEDULED DURING NORMAL BUSINESS HOURS OR DURING FACILITY FUNCTIONS AND ALL COSTS FOR OVERTIME SHALL BE INCLUDED IN THE BID.
- 11. EXISTING LIGHTING FIXTURE BALLASTS AND FLUORESCENT LAMPS MAY CONTAIN PCB'S. DISPOSE OF BALLASTS
- AND LAMPS IN ACCORDANCE WITH EPA. 12. HOLES LEFT BY REMOVAL OF ELECTRICAL DEVICES, PANELS, ETC. SHALL BE PATCHED IN EXISTING WALLS TO
- REMAIN. REFER TO ARCHITECTURAL DRAWINGS.

#### **ABBREVIATIONS**

A A.F.F. A.F.G. BFG C ETR F GFI G	<ul> <li>AMPERES</li> <li>ABOVE FINISHED FLOOR</li> <li>ABOVE FINISHED GRADE</li> <li>BELOW FINISHED GRADE</li> <li>CONDUIT</li> <li>EXISTING TO REMAIN</li> <li>FUSE</li> <li>GROUND FAULT CIRCUIT INTERRUPTING</li> <li>GROUND</li> </ul>	MCB MLO NTS P PNL SN U.O.N. V	- MAIN CIRCUIT BREAKER - MAIN LUG ONLY - NOT TO SCALE - POLE - PANEL - SOLID NEUTRAL - UNLESS OTHERWISE NOTED - VOLTS - WIRE
G KVA KW		W WP	
FILITY NOTES:			

1. PRIOR TO ANY EXCAVATION, CONTRACTOR SHALL HAVE ALL EXISTING UNDERGROUND UTILITIES LOCATED. FIRE PROOFING NOTES:

- ELECTRICAL CONTRACTOR SHALL BE RESPONSIBLE FOR PROVIDING FIRE STOPPING AT ALL WALL, FLOOR AND CEILING PENETRATIONS WHERE CONDUIT PENETRATIONS OCCUR.
- 2. PROVIDE FIRE STOPPING AT CONDUIT PENETRATIONS PER UL.

# DEVICE PLATE NOTE:

ALL COVERPLATES SHALL BE NYLON WITH FINISH PER ARCHITECT. ALL DEVICES (SWITCHES, RECEPTACLES, ETC) SHALL BE FINISH BY ARCHITECT (UON). COORDINATE WITH ARCHITECTURAL PLANS.

LIGHTING CONTROL COMMISSIONING: COMMISSION ALL AUTOMATIC LIGHTING CONTROLS IN ACCORDANCE WITH THE 2015 IECC ENERGY CODE. COORDINATE TESTING WITH


LIGHTING CONTROLS SUPPLIER.

200 Galleria Parkway Suite 1150 Atlanta, GA 30339 404-965-1287 tel 404-601-9859 fax

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# **DEPARTMENT OF HEALTH SERVICES**

Project Number: 23122

Project Name:
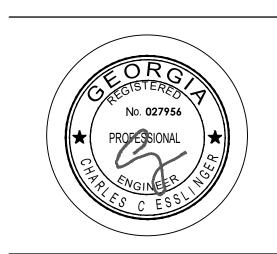
# DHS ROCKDALE COUNTY

975 SW Taylor Street, Conyers, GA 30012

Key Plan:

Sheet Title:

NOTES, **DETAILS**, AND **LEGEND** 

Sheet Number:

**E000** 

ELECTRICAL LEGEND

LIGHTING FIXTURE

EMERGENCY LIGHTING FIXTURE AND/OR NIGHTLIGHT AS INDICATED

EXIT LIGHTING FIXTURE, FACE PLATES (DARKENED) AND DIRECTIONAL ARROWS AS INDICATED. PROVIDE WITH BATTERY BACKUP, UNO. CONNECT AHEAD OF LOCAL SWITCH.

SINGLE POLE SWITCH, 20A, 120/277 VOLT, 46" A.F.F.. THREE-WAY SWITCH, 20A, 120/277 VOLT, 46" A.F.F..

FOUR-WAY SWITCH, 20A, 120/277 VOLT, 46" A.F.F..

DIMMER SWITCH, 46" A.F.F. PROVIDE WATTAGE AS REQUIRED. PROVIDE DIMMER SWITCH COMPATIBLE WITH LED LIGHT FIXTURE. PROVIDE WIRING AS REQUIRED FROM DIMMER TO LIGHT FIXTURE. COORDINATE WITH FIXTURE MANUFACTURER. THREE-WAY SWITCH WITH PILOT LIGHT, 20A, 120/277 VOLT, 46" A.F.F..

CEILING MOUNTED OCCUPANCY SENSOR. BY WATT STOPPER OR APPROVED EQUAL. PROVIDED WITH NUMBER OF SWITCH PACKS AS REQUIRED AND ALL OTHER REQUIRED ACCESSORIES FOR PROPER INSTALLATION.

(2) WALL MOUNTED SWITCHES, 20A, 120/277V, 46"AFF WITH INTEGRAL OCCUPANCY SENSOR. BY WATT STOPPER OR APPROVED

WALL MOUNTED SWITCH, 20A, 120/277V, 46"AFF WITH INTEGRAL OCCUPANCY SENSOR. BY WATT STOPPER OR APPROVED EQUAL. PROVIDED WITH NUMBER OF SWITCH PACKS AS REQUIRED AND ALL OTHER REQUIRED ACCESSORIES FOR PROPER INSTALLATION.

EQUAL. PROVIDED WITH NUMBER OF SWITCH PACKS AS REQUIRED AND ALL OTHER REQUIRED ACCESSORIES FOR PROPER

INSTALLATION. WALL MOUNTED DIMMER SWITCH, 20A, 120/277V, 46"AFF WITH INTEGRAL OCCUPANCY SENSOR. BY WATT STOPPER OR APPROVED EQUAL. PROVIDED WITH NUMBER OF SWITCH PACKS AS REQUIRED AND ALL OTHER REQUIRED ACCESSORIES FOR PROPER

LOW VOLTAGE OVERRIDE SWITCH FOR LIGHTING CONTROLS, 46" A.F.F. PROVIDE LOW VOLTAGE WIRING AS REQUIRED. COORDINATE WITH LIGHTING CONTROL MANUFACTURER.

<u>POWER</u>													
	Ф	DUPLEX	GROUNDING	TYPE	RECEPTACLE,	20A,	125	VOLT,	NEMA	5-20R,	18"	A.F.F.,	U.O.N.

- (2) DUPLEX GROUNDING TYPE RECEPTACLES IN COMMON BOX, 20A, 125 VOLT, NEMA 5-20R, 18" A.F.F, U.O.N
- DUPLEX ISOLATED GROUNDING TYPE RECEPTACLE, 20A, 125 VOLT, NEMA 5-20R, 18" A.F.F., U.O.N.. RECEPTACLE BODY SHALL
- DUPLEX GROUND FAULT INTERRUPTER TYPE RECEPTACLE, 20A, 125 VOLT, NEMA 5-20R, 18" A.F.F., U.O.N.
- WEATHER RESISTANT RATED, DUPLEX GROUND FAULT INTERRUPTER TYPE RECEPTACLE, MOUNT HORIZONTALLY 18" A.F.F., U.O.N., IN CAST OUTLET BOX WITH GASKET DEVICE COVER.
- DUPLEX GROUNDING TYPE RECEPTACLE, 20A, 125 VOLT, NEMA 5-20R. MOUNT HORIZONTALLY 6" A.F.F. FOR WATER COOLER.
- SPECIAL RECEPTACLE, AMPERAGE, AND VOLTAGE AS INDICATED, 18" AFF, UON.
- PROVIDE COMBINATION USB CHARGER AND TAMPER RESISTANT RECEPTACLE. LEVITON DEVICE #T5632. COORDINATE LOCATIONS WITH
- RECEPTACLE/TELEPHONE/DATA OUTLETS, FLUSH MOUNT IN FLUSH MOUNTED FLOOR BOX WITH RUBBER OR THERMOPLASTIC CARPET COVER PLATE. PROVIDE NUMBER AND TYPE OF DEVICES PER PLANS. COORDINATE DEPTH OF FLOOR BOX WITH SLAB DEPTH. COORDINATE EXACT LOCATION WITH ARCHITECT. PROVIDE 3/4" CONDUIT WITH CONDUCTORS INDICATED FOR SERVICE TO RECEPTACLE OUTLET. PROVIDE (1) 1-1/4" CONDUIT WITH PULLWIRE FROM EACH SPECIAL SYSTEMS OUTLET TO ABOVE NEAREST ACCESSIBLE CEILING FOR SPECIAL SYSTEM WIRING BY OTHERS.

#### PANELBOARD

ELECTRICAL CIRCUIT RUN IN CONDUIT AND CIRCUIT HOMERUN TO PANELBOARD (PANEL AND CIRCUIT DESIGNATION AS INDICATED). AS A MINIMUM CONDITION, EACH SINGLE PHASE CIRCUIT SHALL HAVE ONE #12 PHASE CONDUCTOR, ONE #12 NEUTRAL CONDUCTOR, AND ONE #12 GROUNDING CONDUCTOR (PLUS ONE INSULATED, ISOLATED GROUNDING CONDUCTOR WHEN SERVING ISOLATED GROUND TYPE DEVICES) IN 1/2" CONDUIT. PROVIDE ADDITIONAL PHASE CONDUCTORS AS REQUIRED FOR "MULTIPLE PHASED" ELECTRICAL LOADS. PROVIDE ADDITIONAL "SWITCH LEG" CONDUCTORS TO PROVIDE THE LIGHT FIXTURE CONTROL INDICATED. MULTIPLE SINGLE PHASE CONDUCTORS SHALL BE GROUPED TOGETHER IN A COMMON CONDUIT IN ACCORDANCE WITH THE NEC AND AT THE CONTRACTOR'S DISCRETION. MULTIPLE SINGLE PHASE CONDUCTORS SERVING ISOLATED GROUND RECEPTACLES SHALL NOT SHARE COMMON NEUTRALS. NEUTRAL AND GROUNDING CONDUCTORS SHALL BE SHARED AS ALLOWED BY THE NEC. BRANCH CIRCUIT CONDUCTORS IN CONDUIT SHALL BE RUN CONCEALED IN WALLS AND/OR ABOVE CEILINGS, IN/OR BELOW FLOORS, EXCEPT IN EXPOSED CONSTRUCTION AREAS. FLUORESCENT LIGHTING CIRCUITS SERVING SWITCHED FIXTURES WITH EMERGENCY BATTERY BACK-UP SHALL CONTAIN ONE UNSWITCHED CONDUCTOR. FLUORESCENT DIMMING CIRCUITS SERVING DIMMING BALLASTS SHALL BE PROVIDED WITH WIRING AS REQUIRED BY BALLAST MANUFACTURER. MULTIPLE PHASE LIGHTING CIRCUITS SERVING DIMMED LOADS SHALL NOT SHARE COMMON NEUTRALS.

JUNCTION BOX.

DISCONNECT SWITCH, 240 OR 600 VOLTS AS REQUIRED. AMPS, POLES AND FUSING AS NOTED, NEMA 1, U.O.N.

MOTOR RATED SWITCH. MOUNT WITHIN SIGHT OF EQUIPMENT.

MOTOR CONNECTION, WITH INTEGRAL DISCONNECTING MEANS.

STARTER KEYNOTE.

SPECIAL SYSTEMS

# TELEPHONE/DATA OUTLET 18" A.F.F., U.O.N. DOUBLE GANG BOX WITH DEVICE PLATE. PROVIDE 1" (UON) CONDUIT WITH PULLWIRE

- FROM OUTLET TO ABOVE ACCESSIBLE CEILING. PROVIDE WITH SINGLE GANG ADAPTER. TELEPHONE OUTLET 18" A.F.F., U.O.N. DOUBLE GANG BOX WITH DEVICE PLATE. PROVIDE 3/4" (UON) CONDUIT WITH PULLWIRE FROM OUTLET TO ABOVE ACCESSIBLE CEILING. PROVIDE WITH SINGLE GANG ADAPTER.
- TELEVISION OUTLET 18" A.F.F., U.O.N. SINGLE GANG BOX WITH DEVICE PLATE. PROVIDE 3/4" (UON) CONDUIT WITH PULLWIRE FROM OUTLET TO ABOVE ACCESSIBLE CEILING.
- TELEPHONE/TELEVISION BACKBOARD, 4' X 4' X 3/4" THICK EXTERIOR GRADE PLYWOOD. MOUNT VERTICALLY WITH BOTTOM OF PLYWOOD 6" A.F.F., U.O.N.

## FIRE ALARM SYSTEMS

- FIRE ALARM PULL STATION. WALL MOUNT AT 46"A.F.F (ON CENTER)
  - FIRE ALARM HORN/STROBE. WALL MOUNT 80" A.F.F. TO BOTTOM OF LENS, (BOTTOM OF LENS 96" MAX A.F.F OR 6" BELOW FΝ CEILING IN COMPLIANCE WITH NFPA 72.)
  - FIRE ALARM STROBE. WALL MOUNT 80" A.F.F. TO BOTTOM OF LENS, (BOTTOM OF LENS 96" MAX A.F.F OR 6" BELOW CEILING IN COMPLIANCE WITH NFPA 72.)
- FIRE ALARM STROBE. CEILING MOUNT.
- FIRE ALARM HORN/STROBE. CEILING MOUNT.

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Comments 02.23.2024 Issue for Permit

**DEPARTMENT OF HUMAN SERVICES** 

Project Number: 23122 Project Name:

DHS ROCKDALE COUNTY


975 SW Taylor Street, Conyers, GA


Key Plan:

Sheet Title:

**POWER AND LIGHTING PLAN** 

Sheet Number:

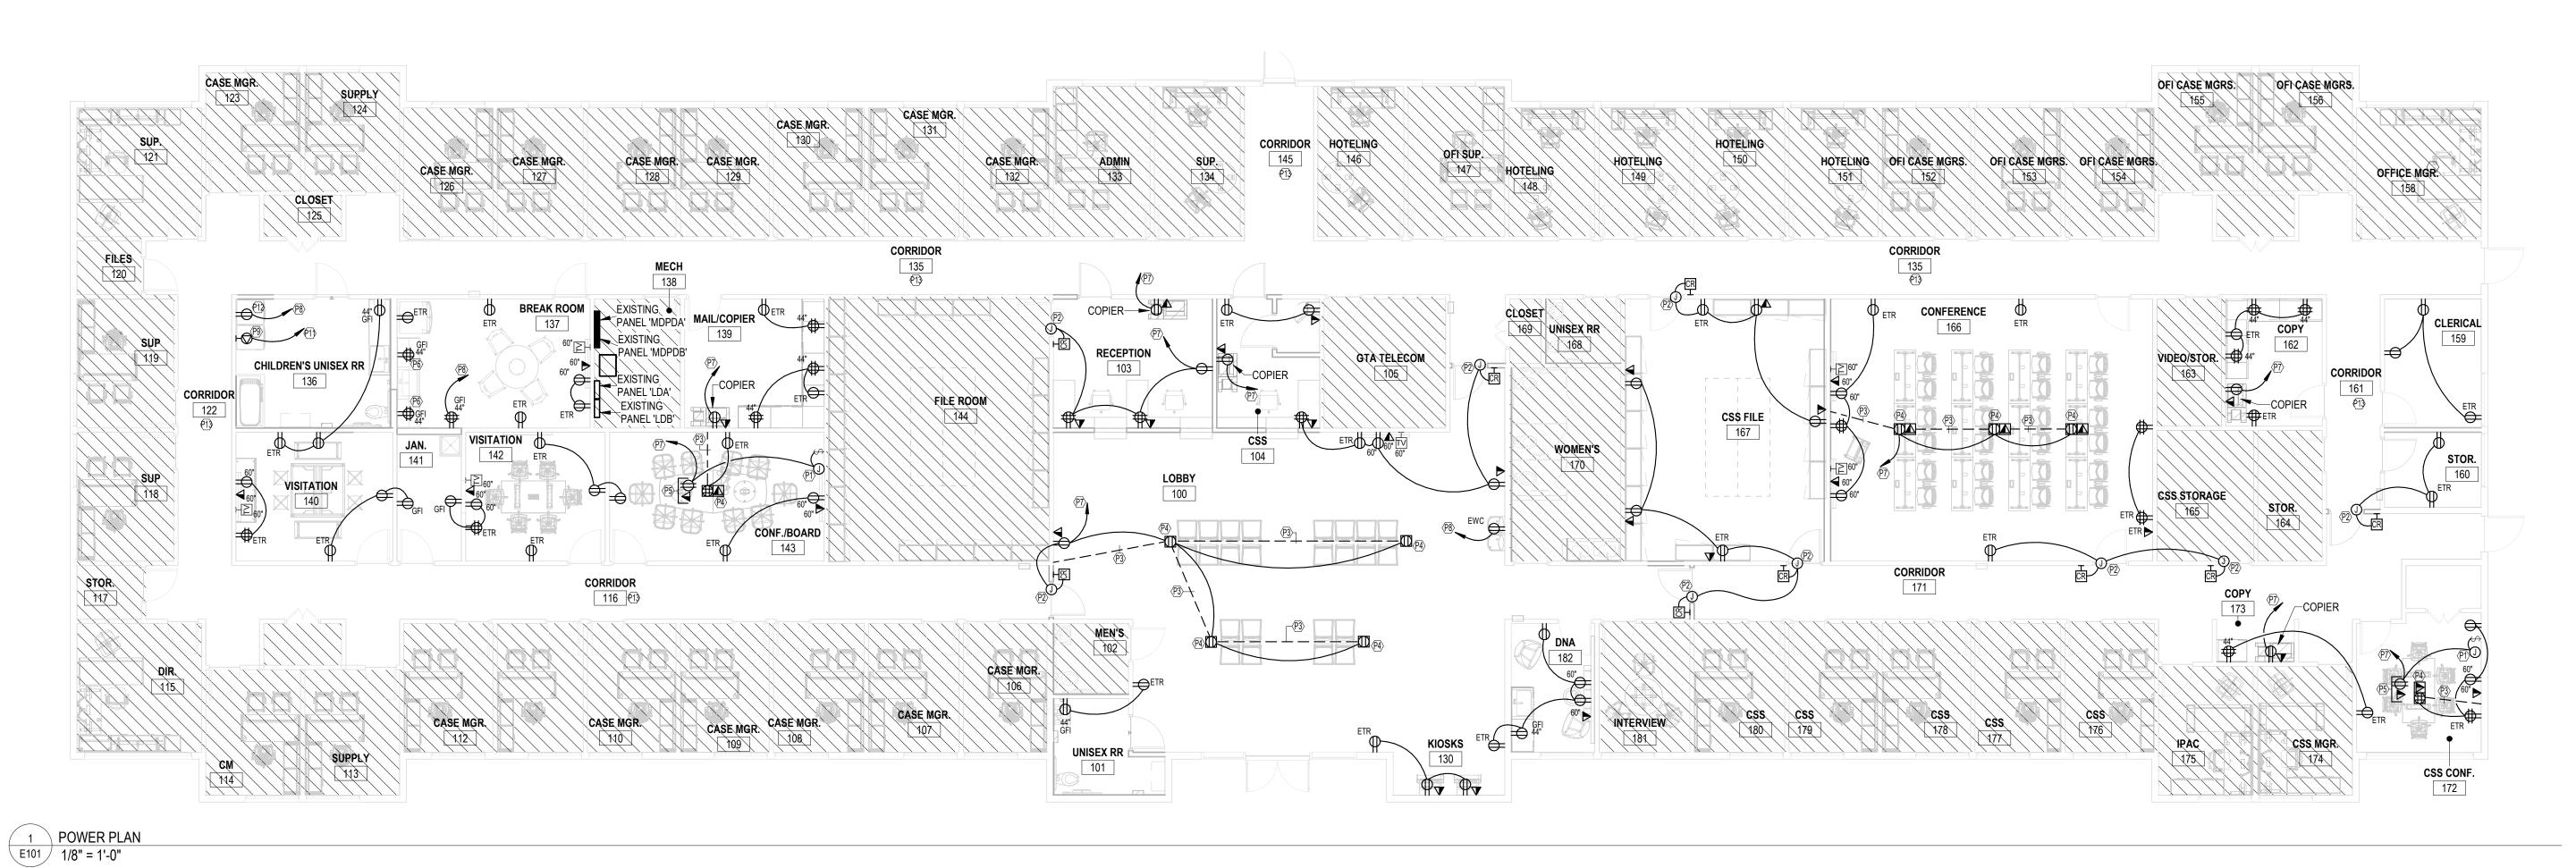

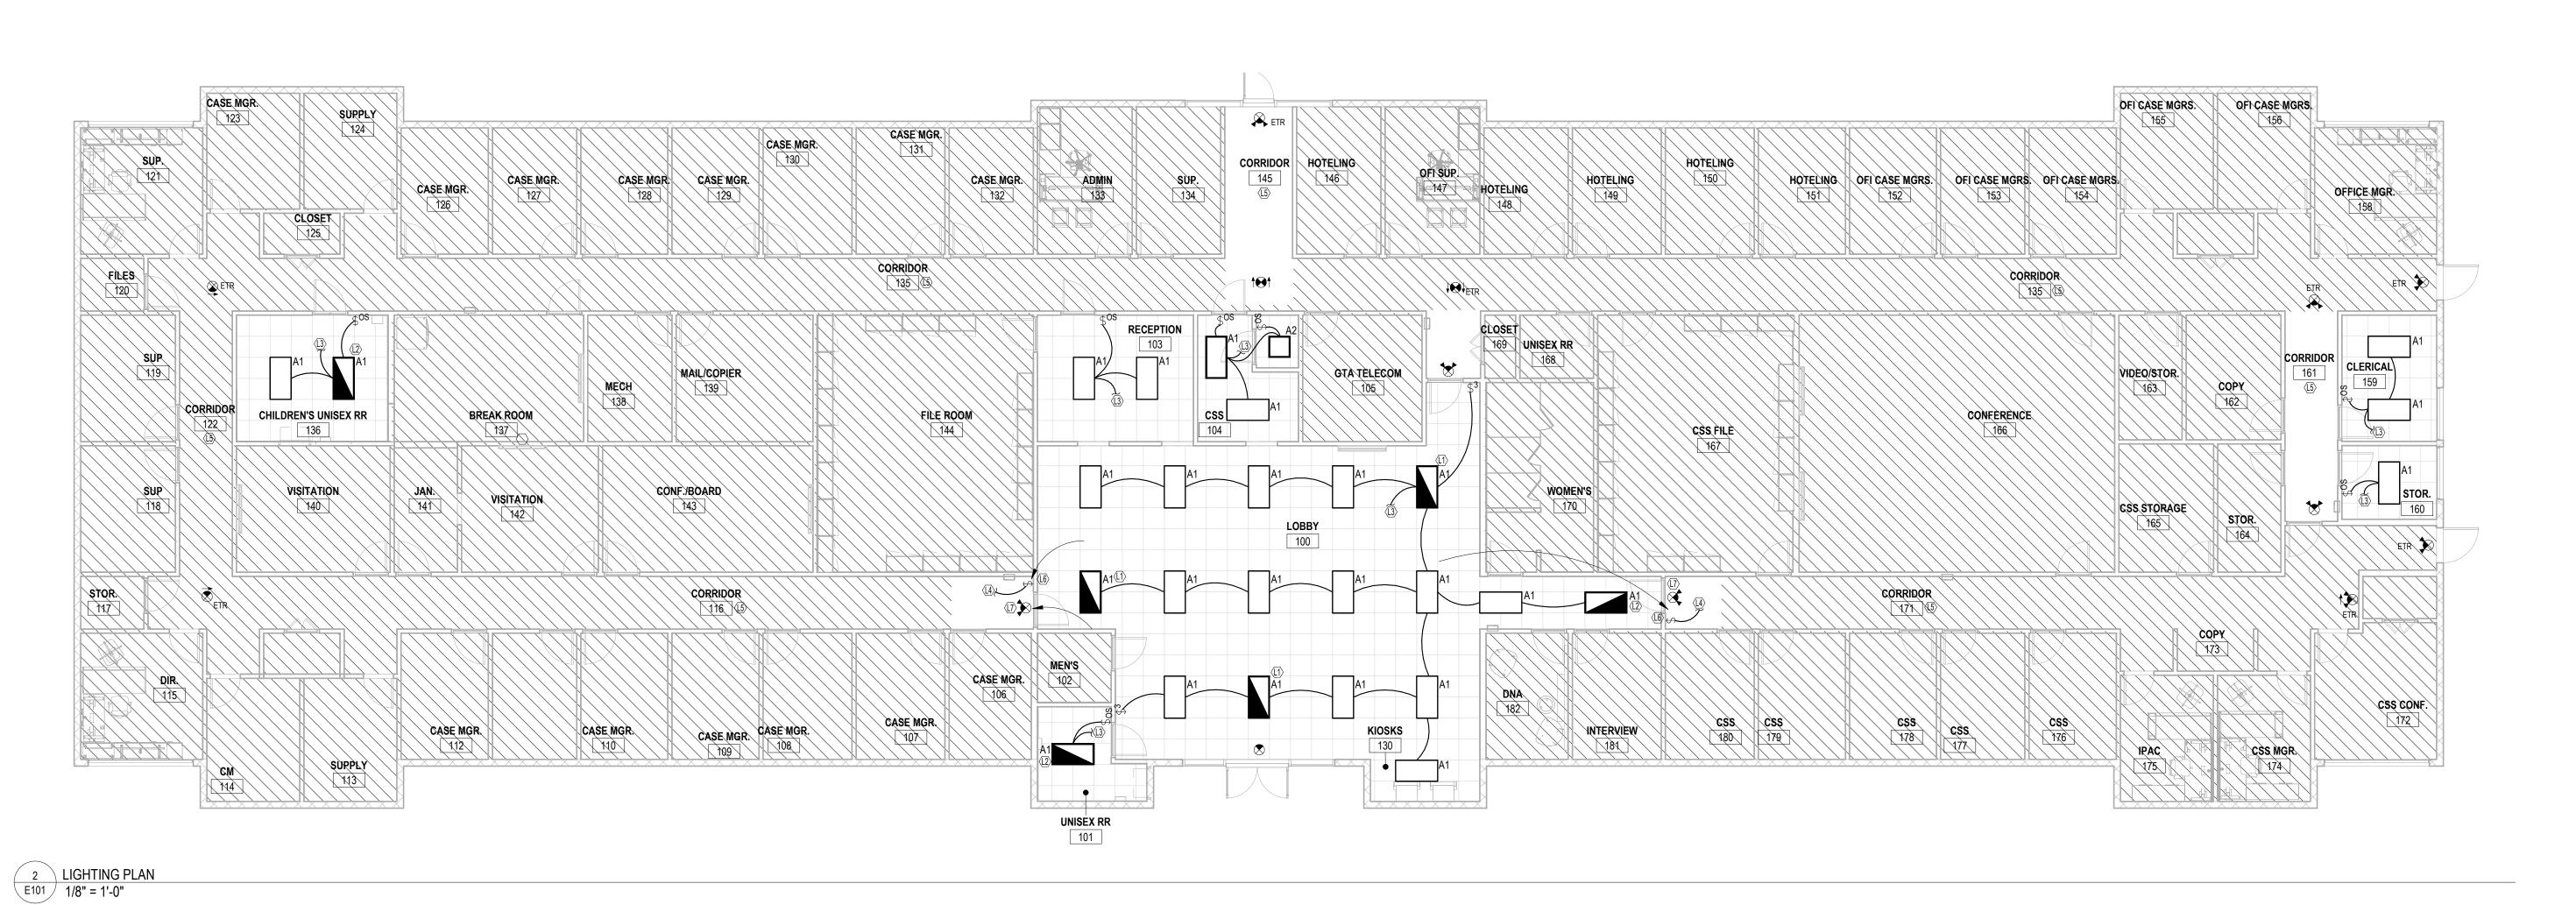

# **ELECTRICAL KEYNOTES**

- L1 FIXTURE SUPPLIED WITH EMERGENCY BATTERY PACK AND SHALL BE WIRED AHEAD OF SWITCH LEG TO SERVE AS NIGHT LIGHT. EMERGENCY BATTERY PACK SHALL
- BECOME ENERGIZED UPON LOSS OF PHASE CONDUCTOR POWER. L2 FIXTURE SUPPLIED WITH EMERGENCY BATTERY PACK. ALL FIXTURE LAMPS SHALL BE SWITCHED ON/OFF. EMERGENCY BATTERY PACK SHALL BECOME ENERGIZED UPON
- LOSS OF CIRCUIT POWER. L3 CONNECT TO EXISTING 277V LIGHTING CIRCUIT FORMERLY SERVING LIGHTING REMOVED.
- L4 RELOCATED SWITCH. CONNECT TO EXISTING CORRIDOR LIGHTING. L5 LIGHT FIXTURES, EMERGENCY, AND EGRESS LIGHT FIXTURES IN CORRIDOR ARE EXISTING TO REMAIN U.O.N.
- L6 RELOCATED CORRIDOR LIGHT SWITCH.
- L7 RELOCATED CORRIDOR EXIT SIGN. P1 PROVIDE JUNCTION BOX FOR PROJECTION SCREEN. COORDIANTE EXACT REQUIREMENTS WITH EQUIPMENT PROVIDER. COORDINATE SWITCH LOCATION WITH
- ARCHITECT PROIOR TO ROUGH-IN. P2 PROVIDE CONDUIT FROM SECURITY DEVICE TO JUNCTION BOX FOR DOOR INTERLOCK UNIT ABOVE CEILING. COORDINATE EXACT REQUIREMENTS WITH SYSTEM
- PROVIDER.
- P3 DATA/TELEPHONE/CATV/POWER CONDUIT(S) TO BE WITHIN SLAB. CUT AND PATCH EXISTING SLAB AS REQUIRED. COORDINATE EXACT REQUIREMENTS IN FIELD. P4 FLOOR BOX SHALL BE WIREMOLD WALKER "RFB4" OR APPROVED EQUAL. FLOOR BOX SHALL BE PROVIDED WITH ALL REQUIRED DEVICES AND ACCESSORIES FOR A PROPER INSTALLATION. PROVIDE WITH BRUSHED ALUMINUM COVER #FPBTAL. PROVIDE (2) 1"C FROM COMPUTER/TELEPHONE OUTLET BELOW SLAB TO ABOVE ACCESSIBLE CEILING. DEDICATE CONDUITS TO SINGLE FLOOR BOX. VERIFY EXACT LOCATION/DIMENSIONS IN WIRING WITH ARCHITECT PRIOR TO INSTALLATION. LOW
- VOLTAGE OUTLETS AND RECEPTACLES SHALL BE COMBINED IN ONE BOX WHERE ADJACENT. REFER TO FLOOR BOX DETAIL, 1/E001. P5 MOUNT RECEPTACLE AND DATA OUTLET IN CEILING FOR PROJECTOR. COORDINATE EXACT LOCATION AND REQUIREMENTS WITH ARCHITECT PRIOR TO ROUGH-IN.
- P6 CONNECT TO EXISTING 120V CIRCUIT FORMERLY SERVING DEVICE REMOVED. P7 CONNECT TO SPARE 20A-1P CIRCUIT BREAKER IN EXISTING PANELS 'LDA' AND 'LDB' MADE AVAILABLE BY DEMOLITION.
- P8 CONNECT TO NEW 20A-1P, GFI CIRCUIT BREAKER IN EXISTING PANEL 'LDA' OR 'LDB' MADE AVAILABLE BY DEMOLITION. PROVIDE BREAKER AS REQUIRED. P9 PROVIDE 208V, 1PH, 30A NEMA RECEPTACLE FOR DRYER. CONNECT TO PANEL INDICATED VIA 3#10, 1#10G-3/4"C.
- P11 CONNECT TO NEW 30A-2P CIRCUIT BREAKER IN EXISTING PANEL 'LDA' OR 'LDB' MADE AVAILABLE BY DEMOLITION. PROVIDE BREAKER AS REQUIRED.
- P12 WASHER; 120V, 1PH. P13 DEVICES ARE EXISTING IN REMAIN IN CORRIDOR U.O.N.

# **GENERAL NOTES**

- 1. HATCH AREA NOT IN SCOPE.
- PULL AN UNSWITCHED PHASE CONDUCTOR TO ALL EMERGENCY AND EGRESS LIGHT FIXTURES U.O.N.